
CITY OF MEMPHIS SHELBY COUNTY, TENNESSEE

BELLEVUE GRAVITY SEWER IMPROVEMENTS JANUARY 2025



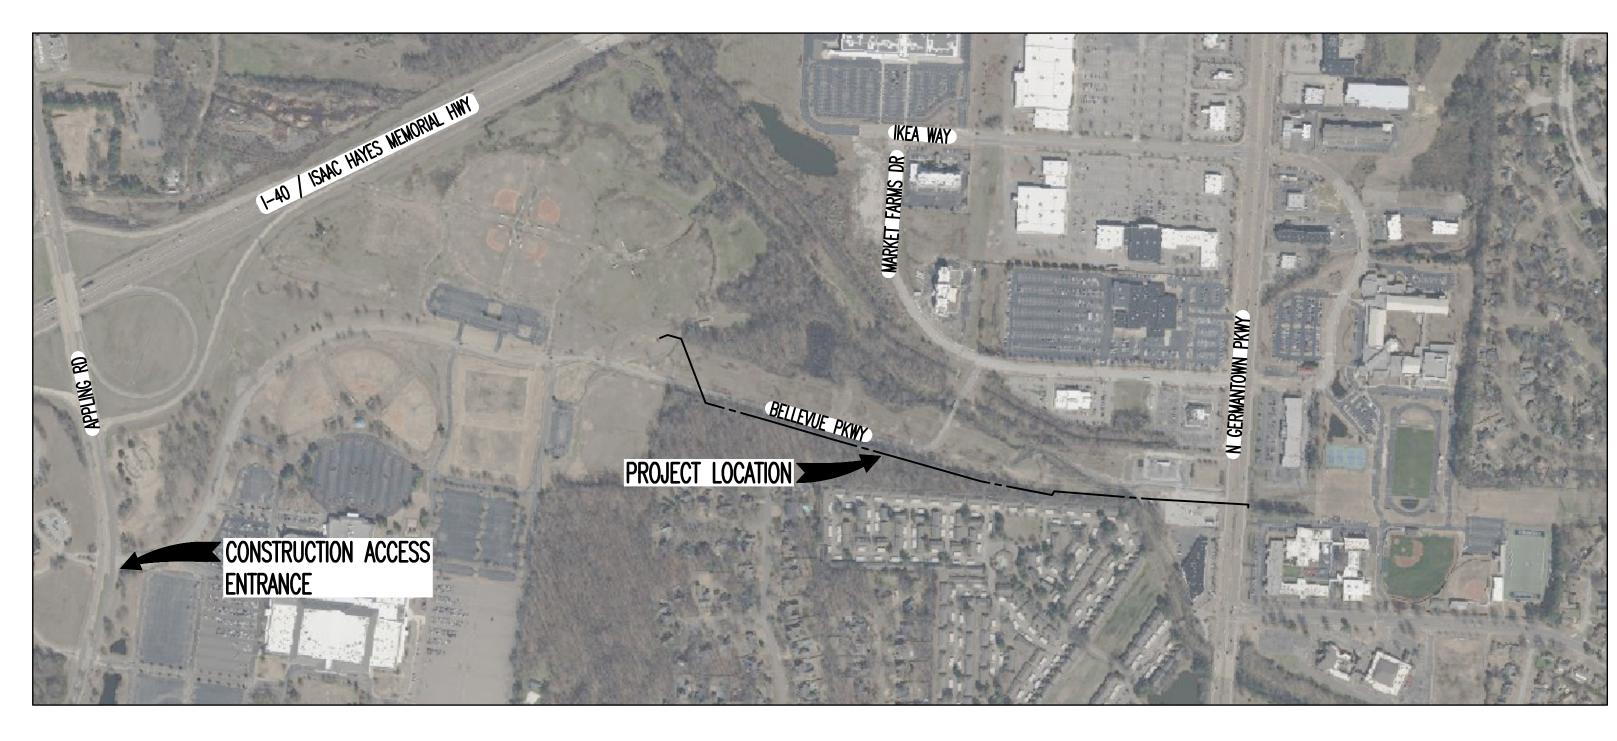

LOCATION MAP: SCALE: 1"=500'

DRAWING INDEX



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- T1.2 TRAFFIC CONTROL PLAN N GERMANTOWN PWKY





TYPICAL CONSTRUCTION NOTES: LOCATION OF EXISTING UNDERGROUND UTILITIES ARE APPROXIMATE AND ARE NOT NECESSARILY ALL OF THE SAME. THE CONTRACTOR SHALL BE RESPONSIBLE FOR CONTACTING THE APPROPRIATE UTILITY COMPANY TO DETERMINE THE EXACT LOCATION OF ALL UTILITIES AND/OR UNDERGROUND STRUCTURES PRIOR TO THE INITIATION OF ANY CONSTRUCTION. CONTRACTOR SHALL ALSO ASSUME FULL RESPONSIBILITY FOR DAMAGE TO

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SERVICE CONNECTIONS BY PROVIDING AMPLE TEMPORARY WASTEWATER PUMPING AND/OR BYPASSING.

CONTRACTOR SHALL MAINTAIN ACCESS TO ALL PROPERTIES.

CONTRACTOR SHALL NOTIFY SARP10 WITH A MINIMUM OF 24 HOURS PRIOR TO BEGINNING ANY CONSTRUCTION.

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14. TRACER WIRE SHALL BE INSTALLED ALONG THE LENGTH OF ALL SEWER PIPES, SERVICE CONNECTIONS, MANHOLES, AND STUBS PER STANDARD CONSTRUCTION SPECIFICATIONS AND STANDARD DETAIL SST-17.

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LINE INSTALLATION. CULVERT REPLACEMENT COST TO BE INCLUDED IN UNIT PRICE OF NEW SEWER LINE. 8. WATER LINES AND OTHER UTILITIES SHOWN FOR INFORMATIONAL PURPOSES. VERIFY LOCATION PRIOR TO CONSTRUCTION TO PREVENT DAMAGE TO EXISTING UTILITIES.

9. REPLACEMENT OF CONCRETE DITCHES SHALL BE IN ACCORDANCE WITH TDOT STANDARD SPECIFICATIONS FOR ROAD AND BRIDGE CONSTRUCTION.

10. EXISTING PIPE SIZES, MATERIALS, MANHOLE DEPTHS, AND LATERAL LOCATIONS TAKEN FROM THE CITY OF MEMPHIS DRAWINGS AND FIFLD INFORMATION.

11. CONTRACTOR TO VERIFY MANHOLE ANGLES, PIPE TYPES AND SIZES, AND, INVERT ELEVATIONS PRIOR TO ORDERING NEW PRECAST MANHOLES.

12. CONTRACTOR SHALL FIELD VERIFY LOCATION OF ALL SEWER LATERALS AND RECONNECT TO NEW SEWER LINE AS NECESSARY. 13. LOCATION OF EXISTING UNDERGROUND UTILITIES ARE APPROXIMATE AND NOT NECESSARILY ALL OF SAME. THE CONTRACTOR SHALL BE RESPONSIBLE FOR CONTACTING THE APPROPRIATE UTILITY COMPANY TO DETERMINE THE EXACT LOCATION OF ALL UTILITIES AND/OR UNDERGROUND STRUCTURES PRIOR TO THE INITIATION OF ANY CONSTRUCTION. CONTRACTOR SHALL ASSUME FULL RESPONSIBILITY FOR DAMAGE TO ANY UTILITIES ENCOUNTERED WITHIN CONSTRUCTION PERIMETERS. FOR SITE LOCATION OF EXISITING UTILITIES INVOLVING MLG&W, SOUTH CENTRAL BELL. AND/OR BOARDWALK PIPELINES. PLEASE CALL 811.

14. CONTRACTOR SHALL MAINTAIN ACCESS TO ALL PROPERTIES.

15. THE CONTRACTOR SHALL VERIFY EXISTING DATA AND REPORT ANY SIGNIFICANT DISCREPANCIES TO THE ENGINEER. 16. THE CONTRACTOR SHALL BE RESPONSIBLE FOR DEWATERING AS NEEDED TO PROPERLY AND SAFELY COMPLETE THE WORK. 17. ALL GRADING WORK SHALL BE PERFORMED IN SUCH A MANNER THAT ADJACENT PROPERTIES ARE NOT DAMAGED OR ADVERSELY AFFECTED.

18. CONTRACTOR SHALL EPOXY COAT ALL PROPOSED MANHOLES. DIVERSION STRUCTURE. WET WELL, AND FLOW CONTROL MANHOLE. IN ACCORDANCE WITH THE SPECIFICATION. 19. THIS SITE IS NOT LOCATED WITHIN A "SPECIAL FLOOD HAZARD AREA" AS DEFINED BY NATIONAL FLOOD

PROTECTION ACT AS SHOWN ON FIRM MAP 47157CO316G AND 47157CO310G, BOTH DATED FEBRUARY 05,2013. THE CLOSEST 100-YEAR FLOOD ELEVATION AT THE STORAGE BASIN SITE IS 281.0

20. NOTE: THE CONSTRUCTION ACCESS REQUIREMENT FROM APPLING ROAD. THE BRIDGE OVER FLETCHER CREEK FROM MARKET FARMS DRIVE TO

BELLEVUE PARKWAY IS LIMITED TO 5 TONS.

GENERAL SANITARY SEWER NOTES:

. ALL SEWER CONSTRUCTION SHALL BE IN ACCORDANCE WITH THE SPECIFICATIONS OF THE CITY OF MEMPHIS, STANDARD CONSTRUCTION SPECIFICATIONS AND SARP10.

2. CONNECTIONS TO EXISTING FACILITIES SHALL BE MADE ONLY UNDER THE SUPERVISION OF A REPRESENTATIVE

BACKFILL FOR SEWER LINES UNDER STREETS AND DRIVEWAYS IS TO BE COMPACTED CRUSHED STONE MEETING CITY OF MEMPHIS STANDARDS.

4. AS-BUILT DRAWINGS MUST BE COMPLETED AND SUBMITTED PRIOR TO ACCEPTANCE OF SEWER LINES BY THE CITY OF MEMPHIS.

5. NO OTHER UTILITIES MAY BE INSTALLED IN THE SAME TRENCH AS THE SEWER LINES OR LATERAL SERVICE

CONTRACTOR SHALL DETERMINE "LIVE OR ABANDONED" STATUS OF ALL EXISTING SERVICES CONNECTED TO MAIN LINE SEGMENTS AS DESIGNATED FOR REPLACEMENT PRIOR TO RE-CONNECTION. ABANDONED OR INACTIVE SERVICES ARE NOT TO BE RECONNECTED TO THE NEW LINE UNLESS DIRECTED BY THE OWNER'S REPRESENTATIVE.

CONTRACTOR SHALL RECONNECT TO EXISTING SEWER LINES IN CONJUNCTION WITH NEW MANHOLE INSTALLATION.

CONTRACTOR SHALL ENSURE UNINTERRUPTED SEWER SERVICES ON EXISTING SEWER AND SERVICE CONNECTIONS BY PROVIDING AMPLE TEMPORARY WASTEWATER PUMPING AND/OR BYPASSING.

9. THE CONTRACTOR SHALL VERIFY EXISTING DATA AND REPORT ANY SIGNIFICANT DISCREPANCIES TO THE

10. MANHOLES LOCATED WITHIN 100-YEAR FLOOD PLAIN SHOULD EXTEND MINIMUM OF 12" (1'-0") ABOVE THE 100-YEAR FLOOD LEVEL REGARDLESS OF WHETHER THE MANHOLE IS IN RESIDENTIAL. COMMERCIAL. OR RURAL PROPERTY. AS AN ALTERNATIVE, A MANHOLE LOCATED WITHIN THE 100-YEAR FLOOD PLAIN MUST HAVE A SEALED COVER AND VENT STACK IF IT EXTENDS LESS THAN THE MINIMUM 12" ABOVE THE 100-YEAR FLOOD LEVEL. WITHIN THIS ALTERNATIVE THE VENT STACK COULD BE LIMITED TO EVERY OTHER MANHOLE IF LOCATED WITHIN A RESIDENTIAL AREA. ANY ALTERNATIVES OTHER THAN WHAT IS SHOWN ON THE PLANS REQUIRES APPROVAL FROM SARP10 PRIOR TO CONSTRUCTION.

SITE PREPARATION NOTES:

1. TOPSOIL SHALL BE STORED ON-SITE FOR USE IN FINAL SITE PREPARATION IN AREAS TO RECEIVE LANDSCAPING AND SEEDING.

2. DO NOT PLACE ASPHALT, CONCRETE, OR FILL OVER FROZEN OR SATURATED SOILS.

PROVIDE POSITIVE DRAINAGE AWAY FROM ALL EARTHWORK.

4. STABILIZE DISTURBED AREAS AFTER COMPLETION OF EARTHWORK.

5. EXCAVATION SLOPES SHALL BE CONSISTENT WITH OSHA REGULATIONS. IN LIEU OF "LAYING BANKS BACK". TIMBER LAGGING AND BRACING, SHEET PILING, OR TRENCH BOXES MAY BE UTILIZED IN ACCORDANCE WITH OSHA REGULATIONS. WORKER SAFETY AND CLASSIFICATION OF SOILS IN EXCAVATIONS ARE THE SOLE RESPONSIBILITY OF THE CONTRACTOR.

6. THE DESIGN OF SHORING SYSTEMS SHALL BE THE RESPONSIBILITY OF THE CONTRACTOR AND SHALL BE PERFORMED BY A COMPETENT PARTY.

7. GROUNDWATER OR POCKETS OF WATER ARE PROBABLE IN EXCAVATIONS AND MUST BE CONTROLLED IN A MANNER THAT DOES NOT COMPROMISE PREPARATION OF THE SUBGRADES FOR STRUCTURES, PIPING, MANHOLES, ETC.

EROSION AND SEDIMENT CONTROL NOTES:

SODDED TO EFFECTIVELY CONTROL SOIL EROSION.

1. CONSTRUCTION ENTRANCES (TO OFFICE OR LAY DOWN AREA, AND TO WORK AREAS) TO BE MINIMUM 6" DEPTH T.D.O.T. NO. 1 OR NO. 2 STONE.

2. INSTALL WATTLES OR SILT FENCE AS DICTATED ON THE EROSION CONTROL PLANS. SEE DETAILS FOR MORE INFORMATION.

3. ALL STOCK PILE AREAS TO BE PROTECTED BY A COMBINATION OF WATTLES AND SILT FENCE.

4. INSTALL INLET PROTECTION DEVICES AT STORM SEWER INLETS PRIOR TO CONSTRUCTION. SEE PLANS FOR LOCATIONS. 5. ALL NEWLY CUT OR FILL AREAS LACKING ADEQUATE VEGETATION SHALL BE FERTILIZED, MULCHED, SEEDED, AND/OR

6. A SPECIFIC INDIVIDUAL SHALL BE DESIGNATED TO BE RESPONSIBLE FOR EROSION AND SEDIMENT CONTROLS ON EACH PROJECT SITE.

7. THE CONTRACTOR SHALL BE RESPONSIBLE FOR MAINTAINING SOIL EROSION CONTROL MEASURES AS NOTED ON THE PLANS. AS REQUESTED BY THE OWNER DURING CONSTRUCTION, AND AS NECESSARY TO PREVENT SEDIMENT FROM LEAVING THE SITE. THE CONTRACTOR SHALL ALSO BE RESPONSIBLE FOR SATISFYING THE REQUIREMENTS OF THE STATE OF TENNESSEE DEPARTMENT OF WATER POLLUTION CONTROL AS SET FORTH IN THE TENNESSEE EROSION & SEDIMENT CONTROL HANDBOOK. ALL SOIL EROSION CONTROL MEASURES SHALL BE MAINTAINED THROUGHOUT THE DURATION OF THE CONTRACT SO AS TO PREVENT ANY SEDIMENTATION FROM WASHING OFF THE SITE ONTO ADJACENT PROPERTY OR PUBLIC RIGHT-OF-WAY. SEDIMENT FENCE SHALL BE INSTALLED AS DIRECTED. THE CONTRACTOR SHALL MAINTAIN A LOG OF ALL MAINTENANCE ACTIVITIES FOR THE EROSION CONTROL ELEMENTS AS REQUIRED BY THE STATE OF TENNESSEE DEPARTMENT OF WATER POLLUTION CONTROL.

9. EROSION AND SEDIMENT CONTROL MEASURES MUST BE IN PLACE AND FUNCTIONAL BEFORE EARTH MOVING OPERATIONS BEGIN, AND MUST BE CONSTRUCTED AND MAINTAINED THROUGHOUT THE CONSTRUCTION PERIOD. TEMPORARY MEASURES MAY BE REMOVED AT THE BEGINNING OF THE WORK DAY, BUT MUST BE REPLACED AT THE END OF THE WORK DAY OR PRIOR TO RAINFALL EVENTS.

8. A COPY OF THE EROSION CONTROL PLAN MUST BE AVAILABLE ON SITE FOR THE DWPC INSPECTOR ON REQUEST.

10. ALL CONTROL MEASURES SHALL BE CHECKED AND STATE REQUIREMENTS FOR MAINTENANCE AND REPAIRS SHALL BE MADE AS NECESSARY, DURING PROLONGED RAINFALL, DAILY CHECKING AND REPAIRING MAY BE NECESSARY. THE PERMITTEE SHALL MAINTAIN RECORDS OF INSPECTION CHECKS, MAINTENANCE AND REPAIRS.

BASIS OF ELEVATIONS NAVD 88 CITY - LOCATED ON THE SOUTHEAST CORNER OF GERMANTOWN PKWY AND CHIMNEYROCK BLVD. AT BACK OF SIDEWALK. ER ON CHIMNEYROCK BLVD. SIDE. ELEV. 296.21

THIS SITE IS NOT LOCATED WITHIN A "SPECIAL FLOOD HAZARD AREA" AS DEFINED BY NATIONAL FLOOD PROTECTION ACT AS SHOWN ON FIRM MAP 47157C0316G AND 47157C0310G. BOTH DATED FEBRUARY 05.2013. THE CLOSEST 100-YEAR FLOOD ELEVATION AT THE STORAGE BASIN SITE IS 281.0

ACCESS AND COORDINATION-BELLEVUE BAPTIST CHURCH: 1. THE CONTRACTOR SHALL COORDINATE INGRESS AND EGRESS OPERATIONS WITH SARP10 TO PREVENT DISRUPTION TO CHURCH OPERATIONS AND SPECIAL EVENTS.

2. MAJOR EQUIPMENT DELIVERIES MUST BE SCHEDULED AROUND PEAK CHURCH TRAFFIC TIMES.

3. CONCRETE POURS REQUIRING MULTIPLE TRUCKS MUST BE SCHEDULED AHEAD OF TIME AND CLOSELY COORDINATE WITH SARP10. MAJOR POURS MY REQUIRE AFTER HOURS WORK AND/OR ADDITIONAL TRAFFIC CONTROLS ON THE SPECIFIED CONSTRUCTION TRAFFIC ROUTE

4. THE BRIDGE ACROSS FLETCHER CREEK FROM MARKET FARMS DRIVER IS LOAD LIMITED TO 5 TONS. NO MATERIALS OR EQUIPMENT DELIVERIES MAY BE ROUTED ACROSS THE BRIDGE. 5.BELLEVUE PARKWAY MUST REMAIN OPEN UNLESS WORK IN THE

ROADWAY IS REQUIRED.

LEGEND

EXIST. SANITARY SEWER MANHOLE	0
EXIST. SEWER CLEANOUT	o C.O.
EXIST. WATER METER	○ W.M.
EXIST. GAS METER	○ G.M.
EXIST. SEWER VALVE	⊳ S.V.
EXIST. WATER VALVE	⊳ W.V.
EXIST. GAS VALVE	⊳ G.V.
EXIST. FIRE HYDRANT ASSEMBLY	\(\)
EXIST. BLOW-OFF VALVE	\vdash
EXIST. AIR RELEASE VALVE	
EXIST. REDUCER	\triangleleft
EXIST. UNDERGROUND TELEPHONE BOX	☐ UG/T BOX
EXIST. POWER POLE	→ P.P
EXIST. LIGHT POLE	О-Ф L.P.
EXIST. CATCH BASIN	C.B.
EXIST. IRON PIN FOUND	• I.P.F.
EXIST. MAIL BOX	M.B.
EXIST. SIGN	<u>O</u>
EXIST. TOP OF BANK	T.O.B.
EXIST. BOTTOM OF BANK	B.O.B.
EXIST. RIP—RAP	
EXIST. PROPERTY LOT NUMBERS	3

NEW SANITARY SEWER MANHOLE NEW SEWER CLEANOUT • C.O. NEW WATER METER W.M. NEW GAS METER • G.M. NEW SEWER VALVE ►S.V. NEW WATER VALVE ₩.V. NEW GAS VALVE ►G.V. NEW FIRE HYDRANT ASSEMBLY ******* NEW BLOW-OFF VALVE ₩ NEW AIR RELEASE VALVE **₽** NEW REDUCER NEW UNDERGROUND TELEPHONE BOX □ UG/T BOX NEW POWER POLE -₽.₽. NEW LIGHT POLE офцр. NEW CATCH BASIN C.B. • I.P.S. NEW IRON PIN SET NEW MAIL BOX NEW SIGN NEW PERMANENT UTILTIY EASEMENT NEW TEMPORARY CONSTRUCTION EASEMENT NEW. RIP-RAP NEW PROPERTY LOT NUMBERS

EXIST. PAVED ROADWAY OR DRIVEWAY EXIST. GRAVEL ROADWAY OR DRIVEWAY EXIST. RIGHT-OF-WAY EXIST. PROPERTY LINE ⊢__ST_____18"ø EXIST. STORM CULVERT EXIST. FENCE EXIST. STREAM/DITCH EXIST. EASEMENT EXIST. WATER LINE EXIST. SANITARY SEWER LINE O—SA——6"——O EXIST. SEWER FORCE MAIN LINE **S**— FM — 6" — **S** EXIST. OVERHEAD ELECTRICAL S-OHE-OHE-S EXIST. UNDERGROUND ELECTRICAL **S**—UGE—UGE——**S** EXIST. OVERHEAD TELEPHONE S OHT OHT EXIST. UNDERGROUND TELEPHONE S-UGT-UGT-G EXIST. OVERHEAD ELEC./TELE/CABLE S-OHETC-S EXIST. UNDERGROUND FIBER OPTIC EXIST. GAS LINE S GAS GAS EXIST. TREELINE EXIST. GUARDRAIL EXIST. MAJOR CONTOURS EXIST. MINOR CONTOURS

NEW PAVED ROADWAY OR DRIVEWAY NEW GRAVEL ROADWAY OR DRIVEWAY NEW RIGHT-OF-WAY NEW PROPERTY LINE **NEW STORM CULVERT** NEW FENCE NEW STREAM/DITCH **NEW EASEMENT** NEW WATER LINE NEW SANITARY GRAVITY SEWER LINE NEW SEWER FORCE MAIN LINE NEW OVERHEAD ELECTRICAL **NEW UNDERGROUND ELECTRICAL** NEW OVERHEAD TELEPHONE **NEW UNDERGROUND TELEPHONE** NEW OVERHEAD ELEC./TELE/CABLE NEW UNDERGROUND FIBER OPTIC NEW GAS LINE NEW. TREELINE **NEW GUARDRAIL** NEW MAJOR CONTOURS NEW MINOR CONTOURS

NEW SILT FENCE **NEW WATTLES/SEDIMENT TUBES** -----NEW DISTURBED AREA LIMITS **5-1---1---1---1--**NEW SILT FENCE NEW WATTLES/SEDIMENT TUBES NEW EROSION CONTROL BLANKET NEW BUFFER ZONE NEW INLET PROTECTION NEW SEDIMENT TRAP 6"ø W.L. NEW OUTLET PROTECTION 8"ø S.L. NEW RIP RAP FILTER RING 12"ø F.M. **NEW CONSTRUCTION ENTRANCE** 0.H.E. NEW CHECK DAM U.G.E. NEW DIVERSION DITCH 0.H.T. NEW CHECK DAM U.G.T. 0.H.E.T.C. NEW SURVEY CONTROL POINT U.G.F.O. NEW SURVEY BENCHMARK GAS 8"ø S.L. (ABANDON) ABANDON SANITARY GRAVITY SEWER LINE O-12"ø F.M. (ABANDON) $\sim\sim\sim\sim\sim$ ABANDON SEWER FORCE MAIN LINE 0 0 0 0 0 0 0 0 ABANDON SANITARY SEWER MANHOLE 0 1200 —

SEWER BASIN WN-10 SHEET 1 OF 1 DMSION OF ENGINEERING SARP10

DESCRIPTION APPROVED

BELLEVUE GRAVITY SEWER IMPROVEMENTS GENERAL NOTES & LEGEND LOCATION: BELLEVUE PARKWAY MEMPHIS. TENNESSEE **SURVEY:** <u>GE</u>ODESY **DATE:** 4/5/2021 **BOOK:** 1/31/2024 SCALEAS SHOWN DRAWN: __ABES__

DESIGN: ABES DATE:

1/31/2024

REVIEWED DATE


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CITY OF MEMPHIS SHELBY COUNTY, TENNESSEE

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5. EXISTING UTILITY SERVICE LINES, METERS, ETC. DAMAGED DURING CONSTRUCTION ARE TO BE REPAIRED OR REPLACED IN ACCORDANCE WITH THE GOVERNING UTILITY REQUIREMENTS.

6. THESE PLANS ARE BASED ON AN ACTUAL FIELD SURVEY AND LAYOUT OF THE SEWER SYSTEM. ANY DISCREPANCIES BETWEEN THE PLAN LOCATIONS AND THE ACTUAL FIELD LOCATIONS SHALL BE IMMEDIATELY COMMUNICATED TO THE DESIGN ENGINEER. 7. CONTRACTOR TO REMOVE EXISTING CULVERTS AND INSTALL NEW CULVERTS UNDER DRIVEWAYS AS REQUIRED FOR NEW SEWER

LINE INSTALLATION. CULVERT REPLACEMENT COST TO BE INCLUDED IN UNIT PRICE OF NEW SEWER LINE. 8. WATER LINES AND OTHER UTILITIES SHOWN FOR INFORMATIONAL PURPOSES. VERIFY LOCATION PRIOR TO CONSTRUCTION TO PREVENT DAMAGE TO EXISTING UTILITIES.

9. REPLACEMENT OF CONCRETE DITCHES SHALL BE IN ACCORDANCE WITH TDOT STANDARD SPECIFICATIONS FOR ROAD AND BRIDGE CONSTRUCTION.

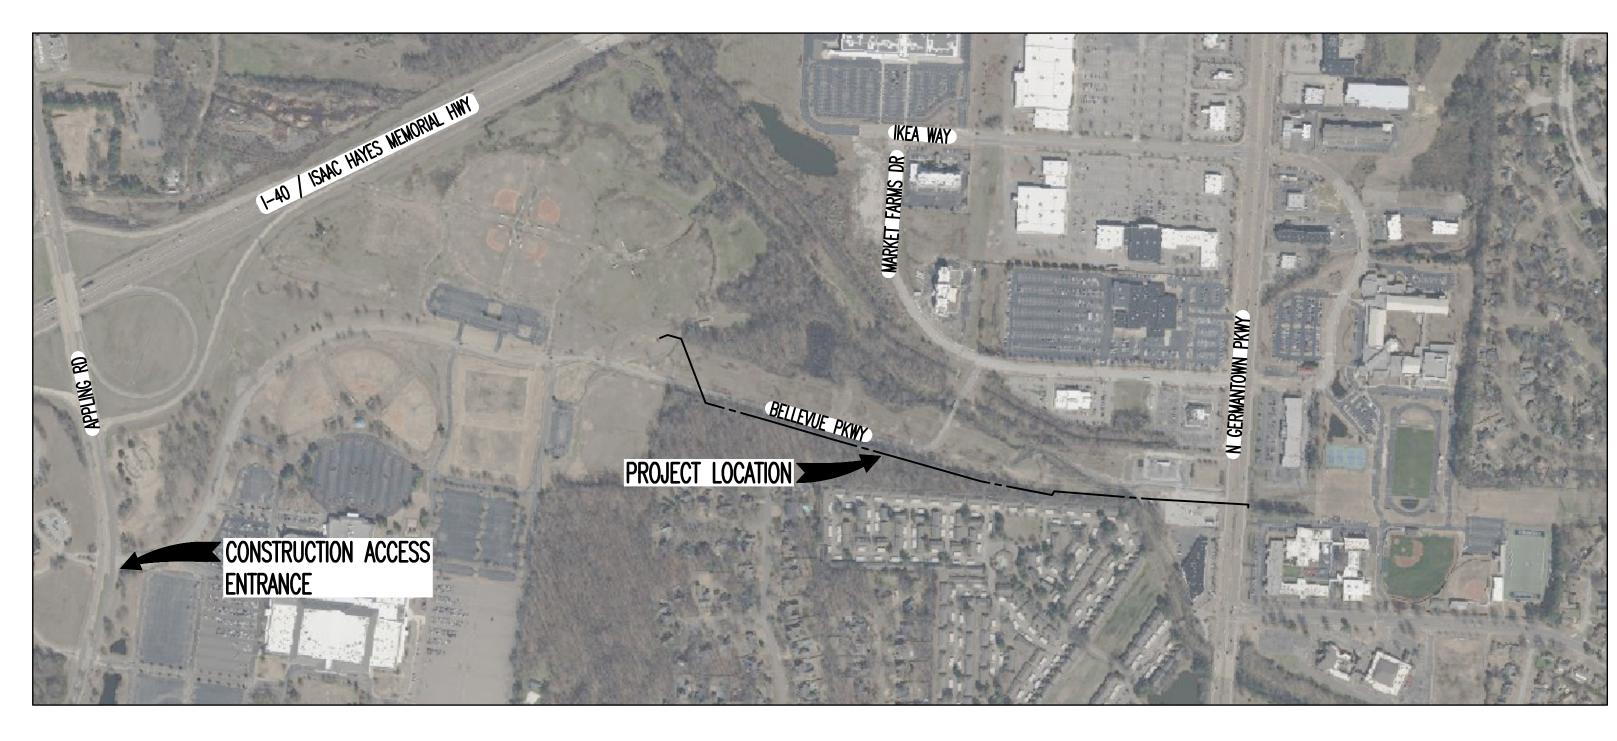10. EXISTING PIPE SIZES, MATERIALS, MANHOLE DEPTHS, AND LATERAL LOCATIONS TAKEN FROM THE CITY OF MEMPHIS DRAWINGS AND FIFLD INFORMATION.

11. CONTRACTOR TO VERIFY MANHOLE ANGLES, PIPE TYPES AND SIZES, AND, INVERT ELEVATIONS PRIOR TO ORDERING NEW PRECAST MANHOLES.

12. CONTRACTOR SHALL FIELD VERIFY LOCATION OF ALL SEWER LATERALS AND RECONNECT TO NEW SEWER LINE AS NECESSARY. 13. LOCATION OF EXISTING UNDERGROUND UTILITIES ARE APPROXIMATE AND NOT NECESSARILY ALL OF SAME, THE CONTRACTOR SHALL BE RESPONSIBLE FOR CONTACTING THE APPROPRIATE UTILITY COMPANY TO DETERMINE THE EXACT LOCATION OF ALL UTILITIES AND/OR UNDERGROUND STRUCTURES PRIOR TO THE INITIATION OF ANY CONSTRUCTION. CONTRACTOR SHALL ASSUME FULL RESPONSIBILITY FOR DAMAGE TO ANY UTILITIES ENCOUNTERED WITHIN CONSTRUCTION PERIMETERS. FOR SITE LOCATION OF EXISITING UTILITIES INVOLVING MLG&W, SOUTH CENTRAL BELL. AND/OR BOARDWALK PIPELINES. PLEASE CALL 811.

14. CONTRACTOR SHALL MAINTAIN ACCESS TO ALL PROPERTIES.

15. THE CONTRACTOR SHALL VERIFY EXISTING DATA AND REPORT ANY SIGNIFICANT DISCREPANCIES TO THE ENGINEER. 16. THE CONTRACTOR SHALL BE RESPONSIBLE FOR DEWATERING AS NEEDED TO PROPERLY AND SAFELY COMPLETE THE WORK. 17. ALL GRADING WORK SHALL BE PERFORMED IN SUCH A MANNER THAT ADJACENT PROPERTIES ARE NOT DAMAGED OR ADVERSELY AFFECTED.

18. CONTRACTOR SHALL EPOXY COAT ALL PROPOSED MANHOLES. DIVERSION STRUCTURE. WET WELL, AND FLOW CONTROL MANHOLE. IN ACCORDANCE WITH THE SPECIFICATION. 19. THIS SITE IS NOT LOCATED WITHIN A "SPECIAL FLOOD HAZARD AREA" AS DEFINED BY NATIONAL FLOOD

PROTECTION ACT AS SHOWN ON FIRM MAP 47157CO316G AND 47157CO310G, BOTH DATED FEBRUARY 05,2013. THE CLOSEST 100-YEAR FLOOD ELEVATION AT THE STORAGE BASIN SITE IS 281.0

20. NOTE: THE CONSTRUCTION ACCESS REQUIREMENT FROM APPLING ROAD. THE BRIDGE OVER FLETCHER CREEK FROM MARKET FARMS DRIVE TO

BELLEVUE PARKWAY IS LIMITED TO 5 TONS.

GENERAL SANITARY SEWER NOTES:

. ALL SEWER CONSTRUCTION SHALL BE IN ACCORDANCE WITH THE SPECIFICATIONS OF THE CITY OF MEMPHIS, STANDARD CONSTRUCTION SPECIFICATIONS AND SARP10.

2. CONNECTIONS TO EXISTING FACILITIES SHALL BE MADE ONLY UNDER THE SUPERVISION OF A REPRESENTATIVE

BACKFILL FOR SEWER LINES UNDER STREETS AND DRIVEWAYS IS TO BE COMPACTED CRUSHED STONE MEETING CITY OF MEMPHIS STANDARDS.

4. AS-BUILT DRAWINGS MUST BE COMPLETED AND SUBMITTED PRIOR TO ACCEPTANCE OF SEWER LINES BY THE CITY OF MEMPHIS.

5. NO OTHER UTILITIES MAY BE INSTALLED IN THE SAME TRENCH AS THE SEWER LINES OR LATERAL SERVICE

CONTRACTOR SHALL DETERMINE "LIVE OR ABANDONED" STATUS OF ALL EXISTING SERVICES CONNECTED TO MAIN LINE SEGMENTS AS DESIGNATED FOR REPLACEMENT PRIOR TO RE-CONNECTION. ABANDONED OR INACTIVE SERVICES ARE NOT TO BE RECONNECTED TO THE NEW LINE UNLESS DIRECTED BY THE OWNER'S REPRESENTATIVE.

CONTRACTOR SHALL RECONNECT TO EXISTING SEWER LINES IN CONJUNCTION WITH NEW MANHOLE INSTALLATION.

CONTRACTOR SHALL ENSURE UNINTERRUPTED SEWER SERVICES ON EXISTING SEWER AND SERVICE CONNECTIONS BY PROVIDING AMPLE TEMPORARY WASTEWATER PUMPING AND/OR BYPASSING.

9. THE CONTRACTOR SHALL VERIFY EXISTING DATA AND REPORT ANY SIGNIFICANT DISCREPANCIES TO THE

10. MANHOLES LOCATED WITHIN 100-YEAR FLOOD PLAIN SHOULD EXTEND MINIMUM OF 12" (1'-0") ABOVE THE 100-YEAR FLOOD LEVEL REGARDLESS OF WHETHER THE MANHOLE IS IN RESIDENTIAL. COMMERCIAL. OR RURAL PROPERTY. AS AN ALTERNATIVE, A MANHOLE LOCATED WITHIN THE 100-YEAR FLOOD PLAIN MUST HAVE A SEALED COVER AND VENT STACK IF IT EXTENDS LESS THAN THE MINIMUM 12" ABOVE THE 100-YEAR FLOOD LEVEL. WITHIN THIS ALTERNATIVE THE VENT STACK COULD BE LIMITED TO EVERY OTHER MANHOLE IF LOCATED WITHIN A RESIDENTIAL AREA. ANY ALTERNATIVES OTHER THAN WHAT IS SHOWN ON THE PLANS REQUIRES APPROVAL FROM SARP10 PRIOR TO CONSTRUCTION.

SITE PREPARATION NOTES:

1. TOPSOIL SHALL BE STORED ON-SITE FOR USE IN FINAL SITE PREPARATION IN AREAS TO RECEIVE LANDSCAPING AND SEEDING.

2. DO NOT PLACE ASPHALT, CONCRETE, OR FILL OVER FROZEN OR SATURATED SOILS.

PROVIDE POSITIVE DRAINAGE AWAY FROM ALL EARTHWORK.

4. STABILIZE DISTURBED AREAS AFTER COMPLETION OF EARTHWORK.

5. EXCAVATION SLOPES SHALL BE CONSISTENT WITH OSHA REGULATIONS. IN LIEU OF "LAYING BANKS BACK". TIMBER LAGGING AND BRACING, SHEET PILING, OR TRENCH BOXES MAY BE UTILIZED IN ACCORDANCE WITH OSHA REGULATIONS. WORKER SAFETY AND CLASSIFICATION OF SOILS IN EXCAVATIONS ARE THE SOLE RESPONSIBILITY OF THE CONTRACTOR.

6. THE DESIGN OF SHORING SYSTEMS SHALL BE THE RESPONSIBILITY OF THE CONTRACTOR AND SHALL BE PERFORMED BY A COMPETENT PARTY.

7. GROUNDWATER OR POCKETS OF WATER ARE PROBABLE IN EXCAVATIONS AND MUST BE CONTROLLED IN A MANNER THAT DOES NOT COMPROMISE PREPARATION OF THE SUBGRADES FOR STRUCTURES, PIPING, MANHOLES, ETC.

EROSION AND SEDIMENT CONTROL NOTES:

SODDED TO EFFECTIVELY CONTROL SOIL EROSION.

1. CONSTRUCTION ENTRANCES (TO OFFICE OR LAY DOWN AREA, AND TO WORK AREAS) TO BE MINIMUM 6" DEPTH T.D.O.T. NO. 1 OR NO. 2 STONE.

2. INSTALL WATTLES OR SILT FENCE AS DICTATED ON THE EROSION CONTROL PLANS. SEE DETAILS FOR MORE INFORMATION.

3. ALL STOCK PILE AREAS TO BE PROTECTED BY A COMBINATION OF WATTLES AND SILT FENCE.

4. INSTALL INLET PROTECTION DEVICES AT STORM SEWER INLETS PRIOR TO CONSTRUCTION. SEE PLANS FOR LOCATIONS. 5. ALL NEWLY CUT OR FILL AREAS LACKING ADEQUATE VEGETATION SHALL BE FERTILIZED, MULCHED, SEEDED, AND/OR

6. A SPECIFIC INDIVIDUAL SHALL BE DESIGNATED TO BE RESPONSIBLE FOR EROSION AND SEDIMENT CONTROLS ON EACH PROJECT SITE.

7. THE CONTRACTOR SHALL BE RESPONSIBLE FOR MAINTAINING SOIL EROSION CONTROL MEASURES AS NOTED ON THE PLANS. AS REQUESTED BY THE OWNER DURING CONSTRUCTION, AND AS NECESSARY TO PREVENT SEDIMENT FROM LEAVING THE SITE. THE CONTRACTOR SHALL ALSO BE RESPONSIBLE FOR SATISFYING THE REQUIREMENTS OF THE STATE OF TENNESSEE DEPARTMENT OF WATER POLLUTION CONTROL AS SET FORTH IN THE TENNESSEE EROSION & SEDIMENT CONTROL HANDBOOK. ALL SOIL EROSION CONTROL MEASURES SHALL BE MAINTAINED THROUGHOUT THE DURATION OF THE CONTRACT SO AS TO PREVENT ANY SEDIMENTATION FROM WASHING OFF THE SITE ONTO ADJACENT PROPERTY OR PUBLIC RIGHT-OF-WAY. SEDIMENT FENCE SHALL BE INSTALLED AS DIRECTED. THE CONTRACTOR SHALL MAINTAIN A LOG OF ALL MAINTENANCE ACTIVITIES FOR THE EROSION CONTROL ELEMENTS AS REQUIRED BY THE STATE OF TENNESSEE DEPARTMENT OF WATER POLLUTION CONTROL.

9. EROSION AND SEDIMENT CONTROL MEASURES MUST BE IN PLACE AND FUNCTIONAL BEFORE EARTH MOVING OPERATIONS BEGIN, AND MUST BE CONSTRUCTED AND MAINTAINED THROUGHOUT THE CONSTRUCTION PERIOD. TEMPORARY MEASURES MAY BE REMOVED AT THE BEGINNING OF THE WORK DAY, BUT MUST BE REPLACED AT THE END OF THE WORK DAY OR PRIOR TO RAINFALL EVENTS.

8. A COPY OF THE EROSION CONTROL PLAN MUST BE AVAILABLE ON SITE FOR THE DWPC INSPECTOR ON REQUEST.

10. ALL CONTROL MEASURES SHALL BE CHECKED AND STATE REQUIREMENTS FOR MAINTENANCE AND REPAIRS SHALL BE MADE AS NECESSARY, DURING PROLONGED RAINFALL, DAILY CHECKING AND REPAIRING MAY BE NECESSARY. THE PERMITTEE SHALL MAINTAIN RECORDS OF INSPECTION CHECKS, MAINTENANCE AND REPAIRS.

BASIS OF ELEVATIONS NAVD 88 CITY - LOCATED ON THE SOUTHEAST CORNER OF GERMANTOWN PKWY AND CHIMNEYROCK BLVD. AT BACK OF SIDEWALK. ER ON CHIMNEYROCK BLVD. SIDE. ELEV. 296.21

THIS SITE IS NOT LOCATED WITHIN A "SPECIAL FLOOD HAZARD AREA" AS DEFINED BY NATIONAL FLOOD PROTECTION ACT AS SHOWN ON FIRM MAP 47157C0316G AND 47157C0310G. BOTH DATED FEBRUARY 05.2013. THE CLOSEST 100-YEAR FLOOD ELEVATION AT THE STORAGE BASIN SITE IS 281.0

ACCESS AND COORDINATION-BELLEVUE BAPTIST CHURCH: 1. THE CONTRACTOR SHALL COORDINATE INGRESS AND EGRESS OPERATIONS WITH SARP10 TO PREVENT DISRUPTION TO CHURCH OPERATIONS AND SPECIAL EVENTS.

2. MAJOR EQUIPMENT DELIVERIES MUST BE SCHEDULED AROUND PEAK CHURCH TRAFFIC TIMES.

3. CONCRETE POURS REQUIRING MULTIPLE TRUCKS MUST BE SCHEDULED AHEAD OF TIME AND CLOSELY COORDINATE WITH SARP10. MAJOR POURS MY REQUIRE AFTER HOURS WORK AND/OR ADDITIONAL TRAFFIC CONTROLS ON THE SPECIFIED CONSTRUCTION TRAFFIC ROUTE

4. THE BRIDGE ACROSS FLETCHER CREEK FROM MARKET FARMS DRIVER IS LOAD LIMITED TO 5 TONS. NO MATERIALS OR EQUIPMENT DELIVERIES MAY BE ROUTED ACROSS THE BRIDGE. 5.BELLEVUE PARKWAY MUST REMAIN OPEN UNLESS WORK IN THE

ROADWAY IS REQUIRED.

LEGEND

EXIST. SANITARY SEWER MANHOLE	0
EXIST. SEWER CLEANOUT	o C.O.
EXIST. WATER METER	○ W.M.
EXIST. GAS METER	○ G.M.
EXIST. SEWER VALVE	⊳ S.V.
EXIST. WATER VALVE	⊳ W.V.
EXIST. GAS VALVE	⊳ G.V.
EXIST. FIRE HYDRANT ASSEMBLY	\Diamond - \triangleright - \vdash
EXIST. BLOW-OFF VALVE	\vdash
EXIST. AIR RELEASE VALVE	
EXIST. REDUCER	\triangleleft
EXIST. UNDERGROUND TELEPHONE BOX	☐ UG/T BOX
EXIST. POWER POLE	→ P.P
EXIST. LIGHT POLE	О-Ф L.P.
EXIST. CATCH BASIN	C.B.
EXIST. IRON PIN FOUND	• I.P.F.
EXIST. MAIL BOX	M.B.
EXIST. SIGN	<u>O</u>
EXIST. TOP OF BANK	T.O.B.
EXIST. BOTTOM OF BANK	B.O.B.
EXIST. RIP—RAP	
EXIST. PROPERTY LOT NUMBERS	3

NEW SANITARY SEWER MANHOLE NEW SEWER CLEANOUT • C.O. NEW WATER METER W.M. NEW GAS METER • G.M. NEW SEWER VALVE ►S.V. NEW WATER VALVE ₩.V. NEW GAS VALVE ►G.V. NEW FIRE HYDRANT ASSEMBLY ******* NEW BLOW-OFF VALVE ₩ NEW AIR RELEASE VALVE **₽** NEW REDUCER NEW UNDERGROUND TELEPHONE BOX □ UG/T BOX NEW POWER POLE -₽.₽. NEW LIGHT POLE офцр. NEW CATCH BASIN C.B. • I.P.S. NEW IRON PIN SET NEW MAIL BOX NEW SIGN NEW PERMANENT UTILTIY EASEMENT NEW TEMPORARY CONSTRUCTION EASEMENT NEW. RIP-RAP NEW PROPERTY LOT NUMBERS

EXIST. PAVED ROADWAY OR DRIVEWAY EXIST. GRAVEL ROADWAY OR DRIVEWAY EXIST. RIGHT-OF-WAY EXIST. PROPERTY LINE ⊢__ST_____18"ø EXIST. STORM CULVERT EXIST. FENCE EXIST. STREAM/DITCH EXIST. EASEMENT EXIST. WATER LINE EXIST. SANITARY SEWER LINE O—SA——6"——O EXIST. SEWER FORCE MAIN LINE **S**— FM — 6" — **S** EXIST. OVERHEAD ELECTRICAL S-OHE-OHE-S EXIST. UNDERGROUND ELECTRICAL **S**—UGE—UGE——**S** EXIST. OVERHEAD TELEPHONE S OHT OHT EXIST. UNDERGROUND TELEPHONE S-UGT-UGT-G EXIST. OVERHEAD ELEC./TELE/CABLE S-OHETC-S EXIST. UNDERGROUND FIBER OPTIC EXIST. GAS LINE S GAS GAS EXIST. TREELINE EXIST. GUARDRAIL EXIST. MAJOR CONTOURS EXIST. MINOR CONTOURS

NEW PAVED ROADWAY OR DRIVEWAY NEW GRAVEL ROADWAY OR DRIVEWAY NEW RIGHT-OF-WAY NEW PROPERTY LINE **NEW STORM CULVERT** NEW FENCE NEW STREAM/DITCH **NEW EASEMENT** NEW WATER LINE NEW SANITARY GRAVITY SEWER LINE NEW SEWER FORCE MAIN LINE NEW OVERHEAD ELECTRICAL **NEW UNDERGROUND ELECTRICAL** NEW OVERHEAD TELEPHONE **NEW UNDERGROUND TELEPHONE** NEW OVERHEAD ELEC./TELE/CABLE NEW UNDERGROUND FIBER OPTIC NEW GAS LINE NEW. TREELINE **NEW GUARDRAIL** NEW MAJOR CONTOURS NEW MINOR CONTOURS

NEW SILT FENCE **NEW WATTLES/SEDIMENT TUBES** -----NEW DISTURBED AREA LIMITS **5-1---1---1---1--**NEW SILT FENCE NEW WATTLES/SEDIMENT TUBES NEW EROSION CONTROL BLANKET NEW BUFFER ZONE NEW INLET PROTECTION NEW SEDIMENT TRAP 6"ø W.L. NEW OUTLET PROTECTION 8"ø S.L. NEW RIP RAP FILTER RING 12"ø F.M. **NEW CONSTRUCTION ENTRANCE** 0.H.E. NEW CHECK DAM U.G.E. NEW DIVERSION DITCH 0.H.T. NEW CHECK DAM U.G.T. 0.H.E.T.C. NEW SURVEY CONTROL POINT U.G.F.O. NEW SURVEY BENCHMARK GAS 8"ø S.L. (ABANDON) ABANDON SANITARY GRAVITY SEWER LINE O-12"ø F.M. (ABANDON) $\sim\sim\sim\sim\sim$ ABANDON SEWER FORCE MAIN LINE 0 0 0 0 0 0 0 0 ABANDON SANITARY SEWER MANHOLE 0 1200 —

SEWER BASIN WN-10 SHEET 1 OF 1 DMSION OF ENGINEERING SARP10

DESCRIPTION APPROVED

BELLEVUE GRAVITY SEWER IMPROVEMENTS GENERAL NOTES & LEGEND LOCATION: BELLEVUE PARKWAY MEMPHIS. TENNESSEE **SURVEY:** <u>GE</u>ODESY **DATE:** 4/5/2021 **BOOK:** 1/31/2024 SCALEAS SHOWN DRAWN: __ABES__


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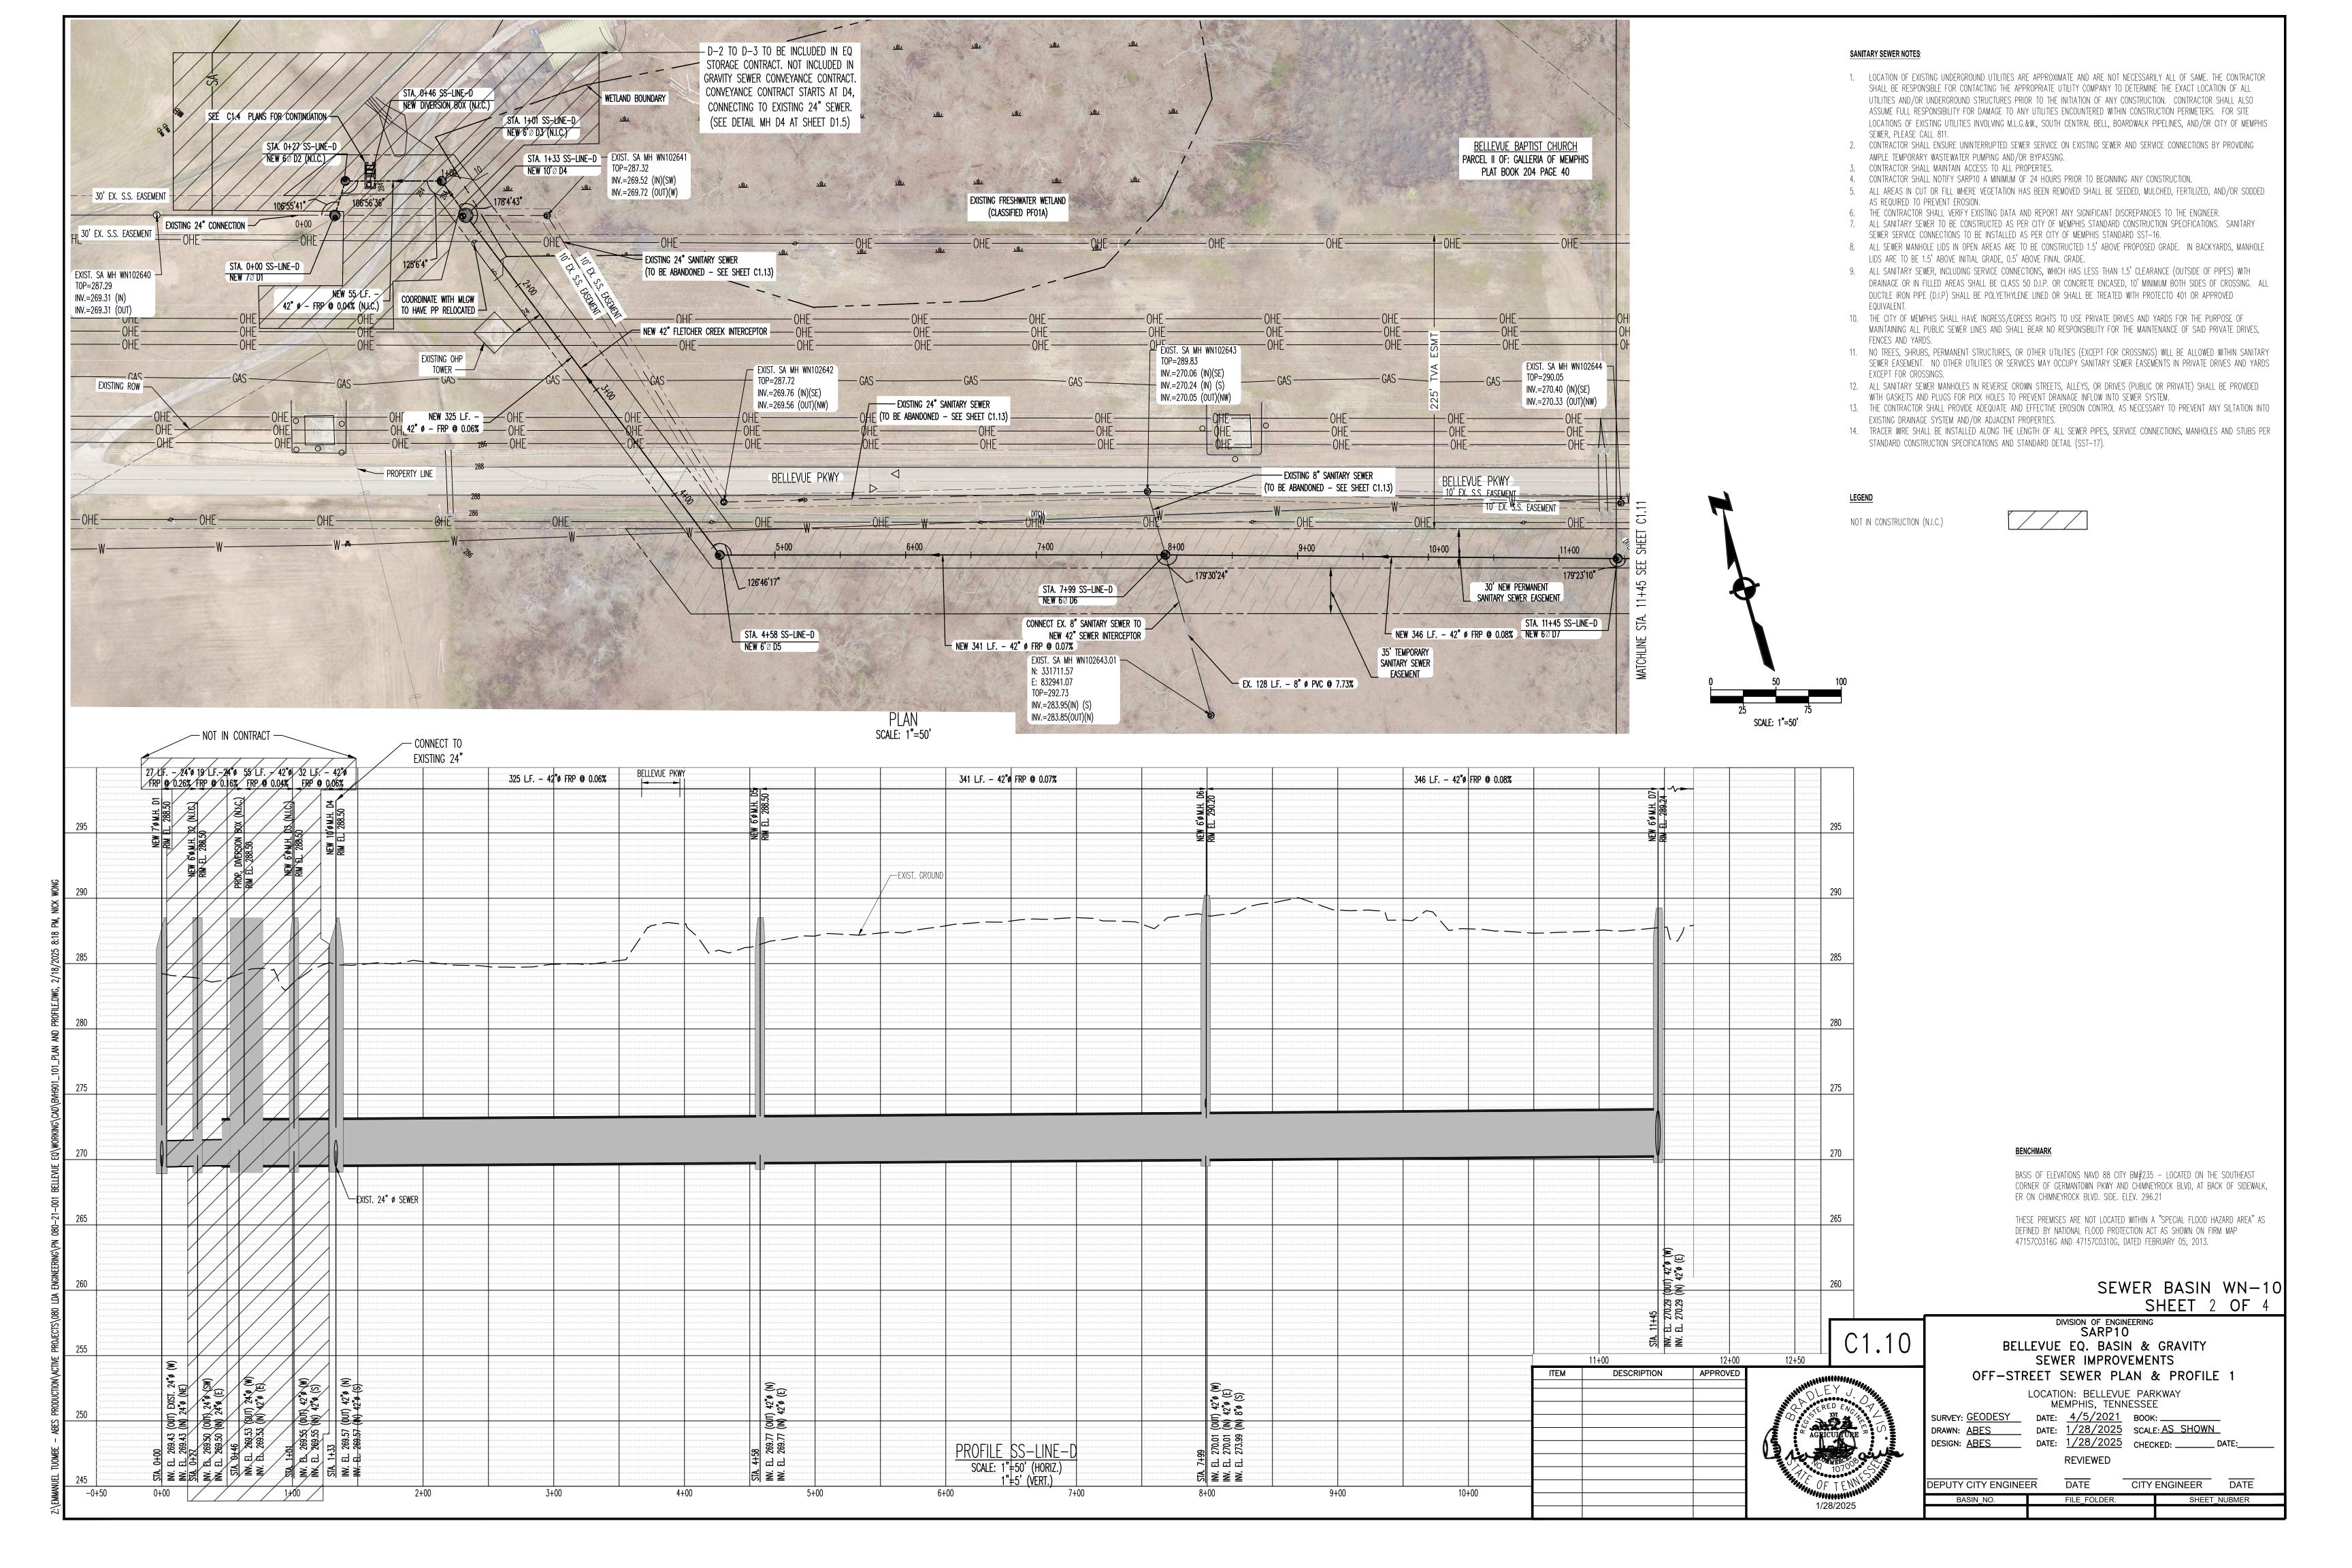
1/31/2024


REVIEWED DATE


DATE EPUTY CITY ENGINEER CITY ENGINEER BASIN NO. FILE FOLDER SHEET NO.

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SANITARY SEWER NOTES:

- 1. LOCATION OF EXISTING UNDERGROUND UTILITIES ARE APPROXIMATE AND ARE NOT NECESSARILY ALL OF SAME. THE CONTRACTOR SHALL BE RESPONSIBLE FOR CONTACTING THE APPROPRIATE UTILITY COMPANY TO DETERMINE THE EXACT LOCATION OF ALL UTILITIES AND/OR UNDERGROUND STRUCTURES PRIOR TO THE INITIATION OF ANY CONSTRUCTION. CONTRACTOR SHALL ALSO ASSUME FULL RESPONSIBILITY FOR DAMAGE TO ANY UTILITIES ENCOUNTERED WITHIN CONSTRUCTION PERIMETERS. FOR SITE LOCATIONS OF EXISTING UTILITIES INVOLVING M.L.G.&W., SOUTH CENTRAL BELL, BOARDWALK PIPELINES, AND/OR CITY OF MEMPHIS SEWER, PLEASE CALL 811.
- 2. CONTRACTOR SHALL ENSURE UNINTERRUPTED SEWER SERVICE ON EXISTING SEWER AND SERVICE CONNECTIONS BY PROVIDING AMPLE TEMPORARY WASTEWATER PUMPING AND/OR BYPASSING.
- 3. CONTRACTOR SHALL MAINTAIN ACCESS TO ALL PROPERTIES.
- 4. CONTRACTOR SHALL NOTIFY SARP10 A MINIMUM OF 24 HOURS PRIOR TO BEGINNING ANY CONSTRUCTION.
- 5. ALL AREAS IN CUT OR FILL WHERE VEGETATION HAS BEEN REMOVED SHALL BE SEEDED, MULCHED, FERTILIZED, AND/OR SODDED AS REQUIRED TO PREVENT EROSION.
- 6. THE CONTRACTOR SHALL VERIFY EXISTING DATA AND REPORT ANY SIGNIFICANT DISCREPANCIES TO THE ENGINEER.
- 7. ALL SANITARY SEWER TO BE CONSTRUCTED AS PER CITY OF MEMPHIS STANDARD CONSTRUCTION SPECIFICATIONS. SANITARY SEWER SERVICE CONNECTIONS TO BE INSTALLED AS PER CITY OF MEMPHIS STANDARD SST-16.
- 8. ALL SEWER MANHOLE LIDS IN OPEN AREAS ARE TO BE CONSTRUCTED 1.5' ABOVE PROPOSED GRADE. IN BACKYARDS, MANHOLE LIDS ARE TO BE 1.5' ABOVE INITIAL GRADE, 0.5' ABOVE FINAL GRADE.
- 9. ALL SANITARY SEWER, INCLUDING SERVICE CONNECTIONS, WHICH HAS LESS THAN 1.5' CLEARANCE (OUTSIDE OF PIPES) WITH DRAINAGE OR IN FILLED AREAS SHALL BE CLASS 50 D.I.P. OR CONCRETE ENCASED, 10' MINIMUM BOTH SIDES OF CROSSING. ALL DUCTILE IRON PIPE (D.I.P) SHALL BE POLYETHYLENE LINED OR SHALL BE TREATED WITH PROTECTO 401 OR APPROVED
- 10. THE CITY OF MEMPHIS SHALL HAVE INGRESS/EGRESS RIGHTS TO USE PRIVATE DRIVES AND YARDS FOR THE PURPOSE OF MAINTAINING ALL PUBLIC SEWER LINES AND SHALL BEAR NO RESPONSIBILITY FOR THE MAINTENANCE OF SAID PRIVATE DRIVES, FENCES AND YARDS.
- 11. NO TREES, SHRUBS, PERMANENT STRUCTURES, OR OTHER UTILITIES (EXCEPT FOR CROSSINGS) WILL BE ALLOWED WITHIN SANITARY SEWER EASEMENT. NO OTHER UTILITIES OR SERVICES MAY OCCUPY SANITARY SEWER EASEMENTS IN PRIVATE DRIVES AND YARDS EXCEPT FOR CROSSINGS.
- 12. ALL SANITARY SEWER MANHOLES IN REVERSE CROWN STREETS, ALLEYS, OR DRIVES (PUBLIC OR PRIVATE) SHALL BE PROVIDED WITH GASKETS AND PLUGS FOR PICK HOLES TO PREVENT DRAINAGE INFLOW INTO SEWER SYSTEM.
- 13. THE CONTRACTOR SHALL PROVIDE ADEQUATE AND EFFECTIVE EROSION CONTROL AS NECESSARY TO PREVENT ANY SILTATION INTO EXISTING DRAINAGE SYSTEM AND/OR ADJACENT PROPERTIES.
- 14. TRACER WIRE SHALL BE INSTALLED ALONG THE LENGTH OF ALL SEWER PIPES, SERVICE CONNECTIONS, MANHOLES AND STUBS PER STANDARD CONSTRUCTION SPECIFICATIONS AND STANDARD DETAIL (SST-17).

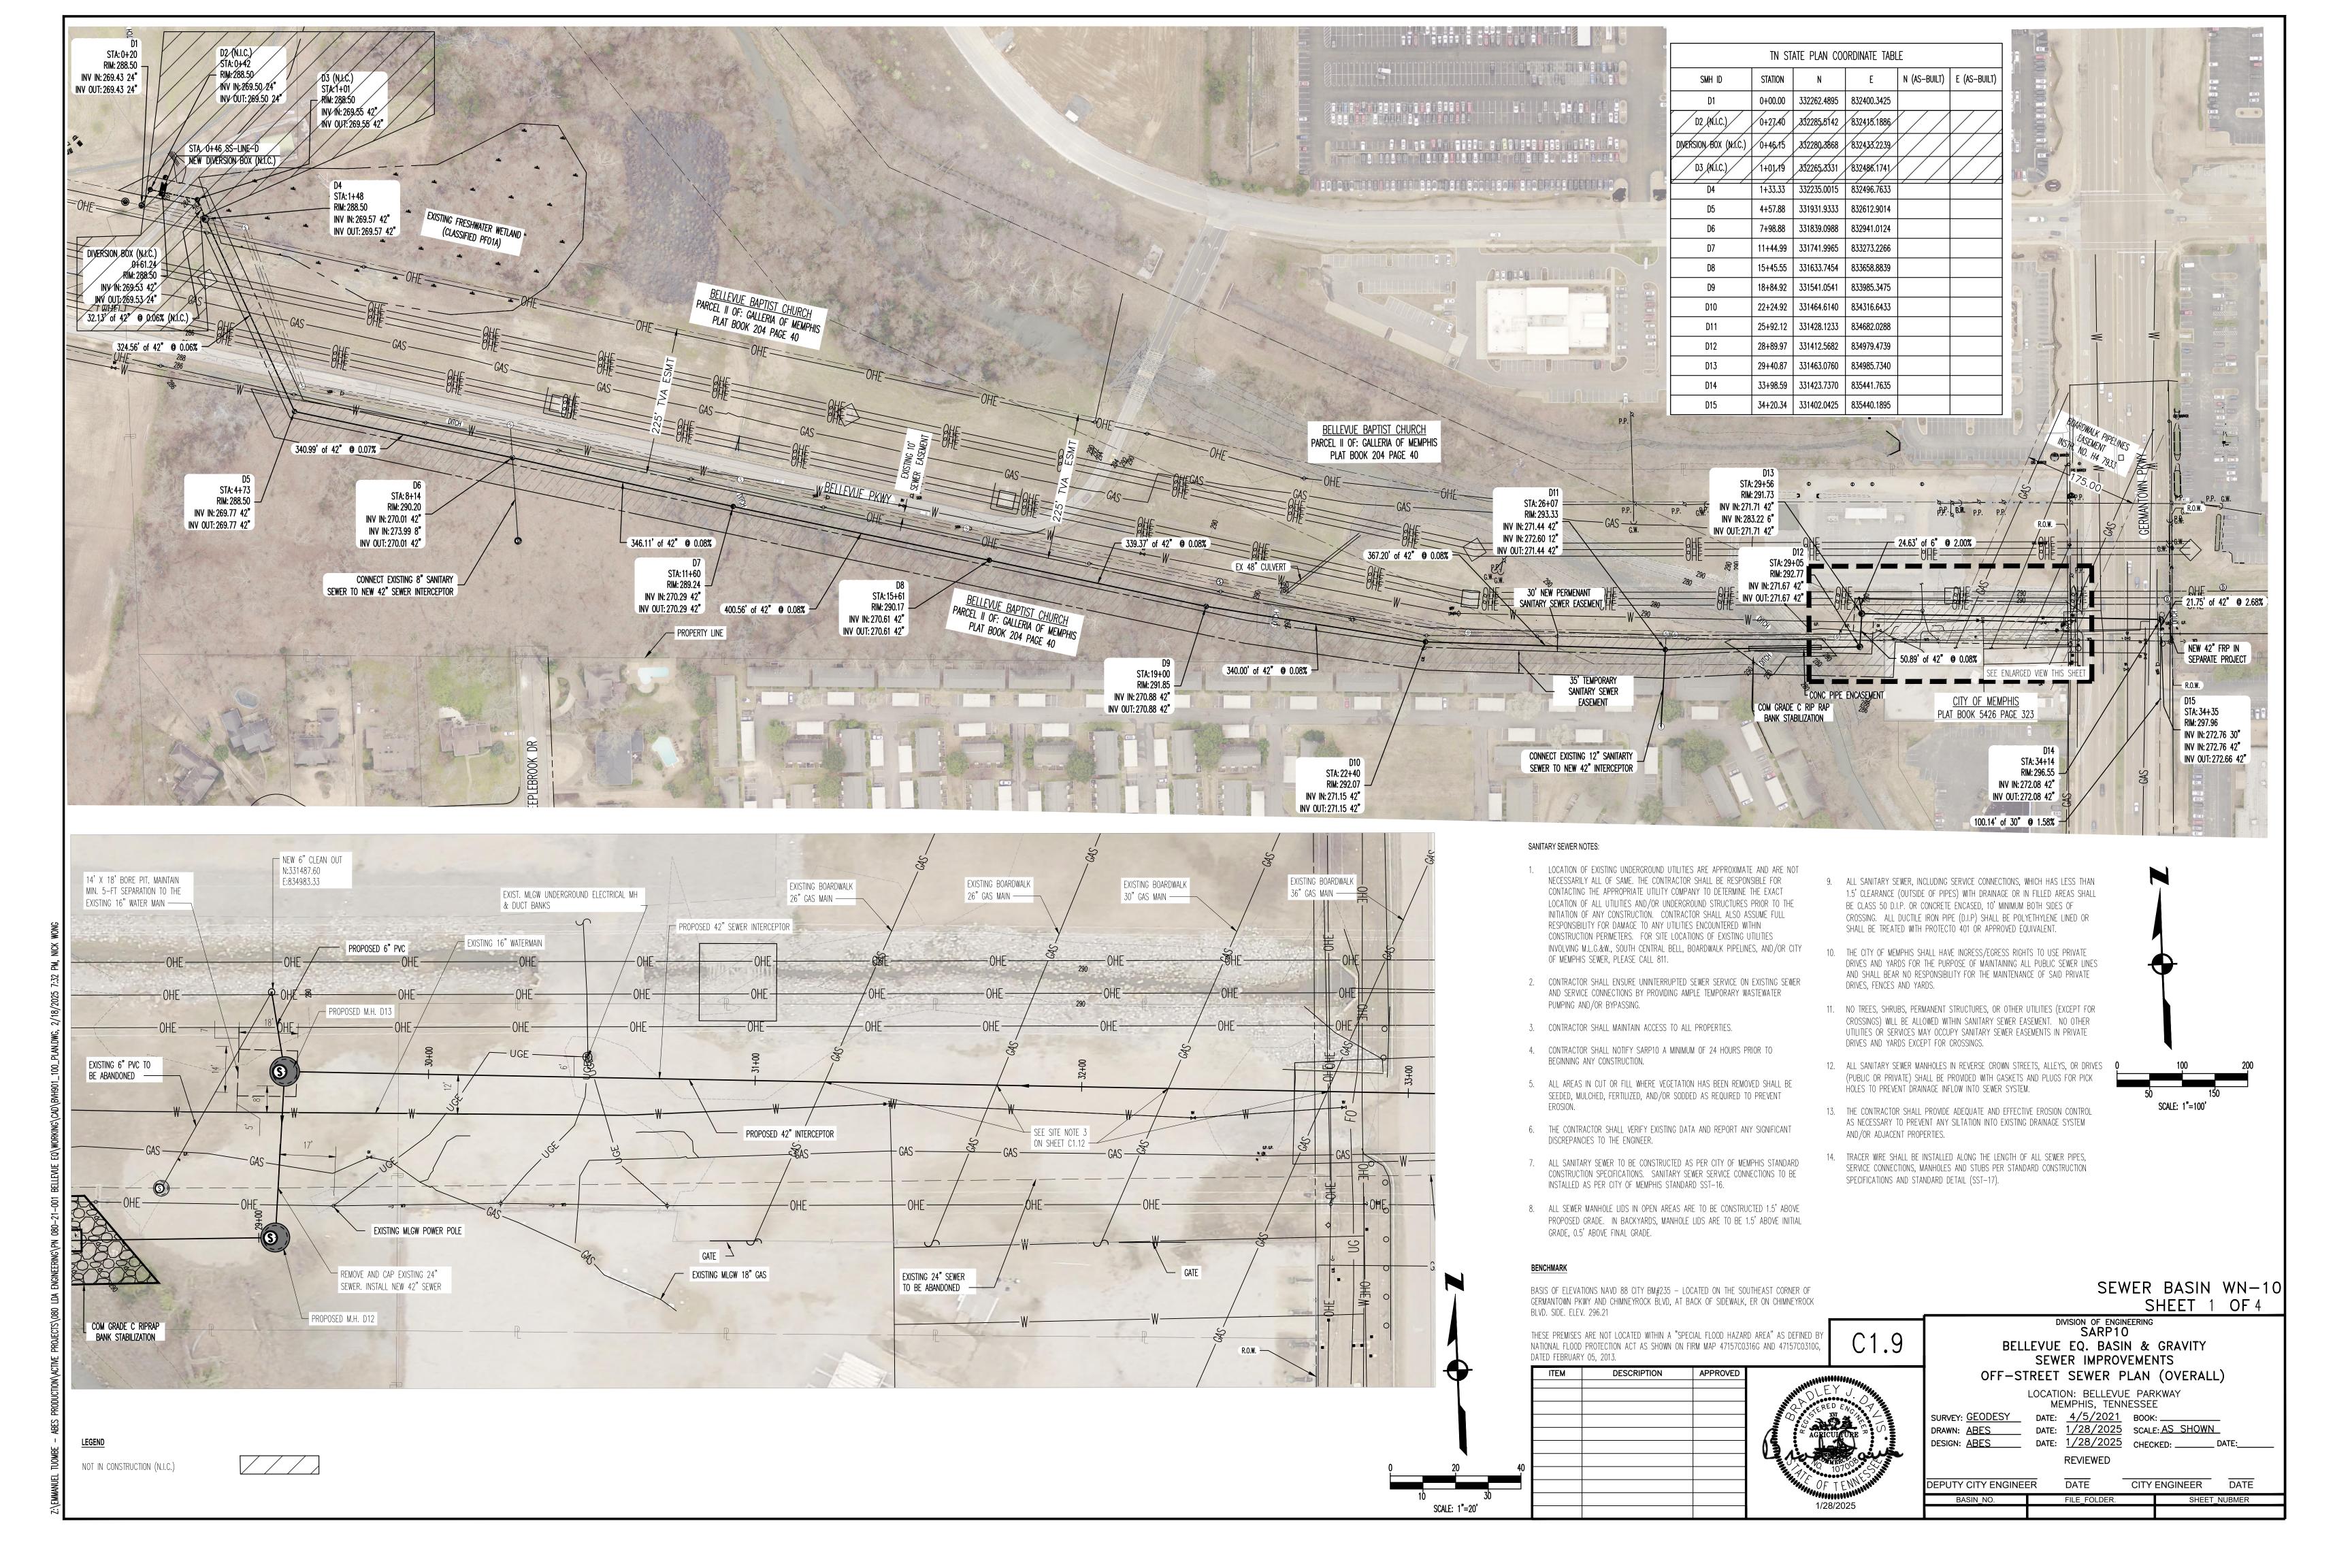STRUCTURE A	BANDON	MENT TABLE
STRUCTURE ID	DEPTH	LOCATION
MH WN102650	25.80	N: 331402.042 E: 835440.190
MH WN102649	22.13	N: 331429.942 E: 834945.674
MH WN102643.01	9.38	N: 331711.568 E: 832941.067
MH WN102647	21.37	N: 331474.314 E: 834382.572
MH WN102646	21.37	N: 331577.256 E: 834008.634
MH WN102648	19.00	N: 331452.261 E: 834684.993
MH WN102648A	20.20	N: 331449.887 E: 834698.424
MH WN102644	20.22	N: 331782.218 E: 833287.248
MH WN102643	20.28	N: 331889.540 E: 832940.991
MH WN102645	19.25	N: 331684.710 E: 833627.158
MH WN102642	18.66	N: 331970.128 E: 832626.850
MH WN102641	18.30	N: 332217.998 E: 832556.504

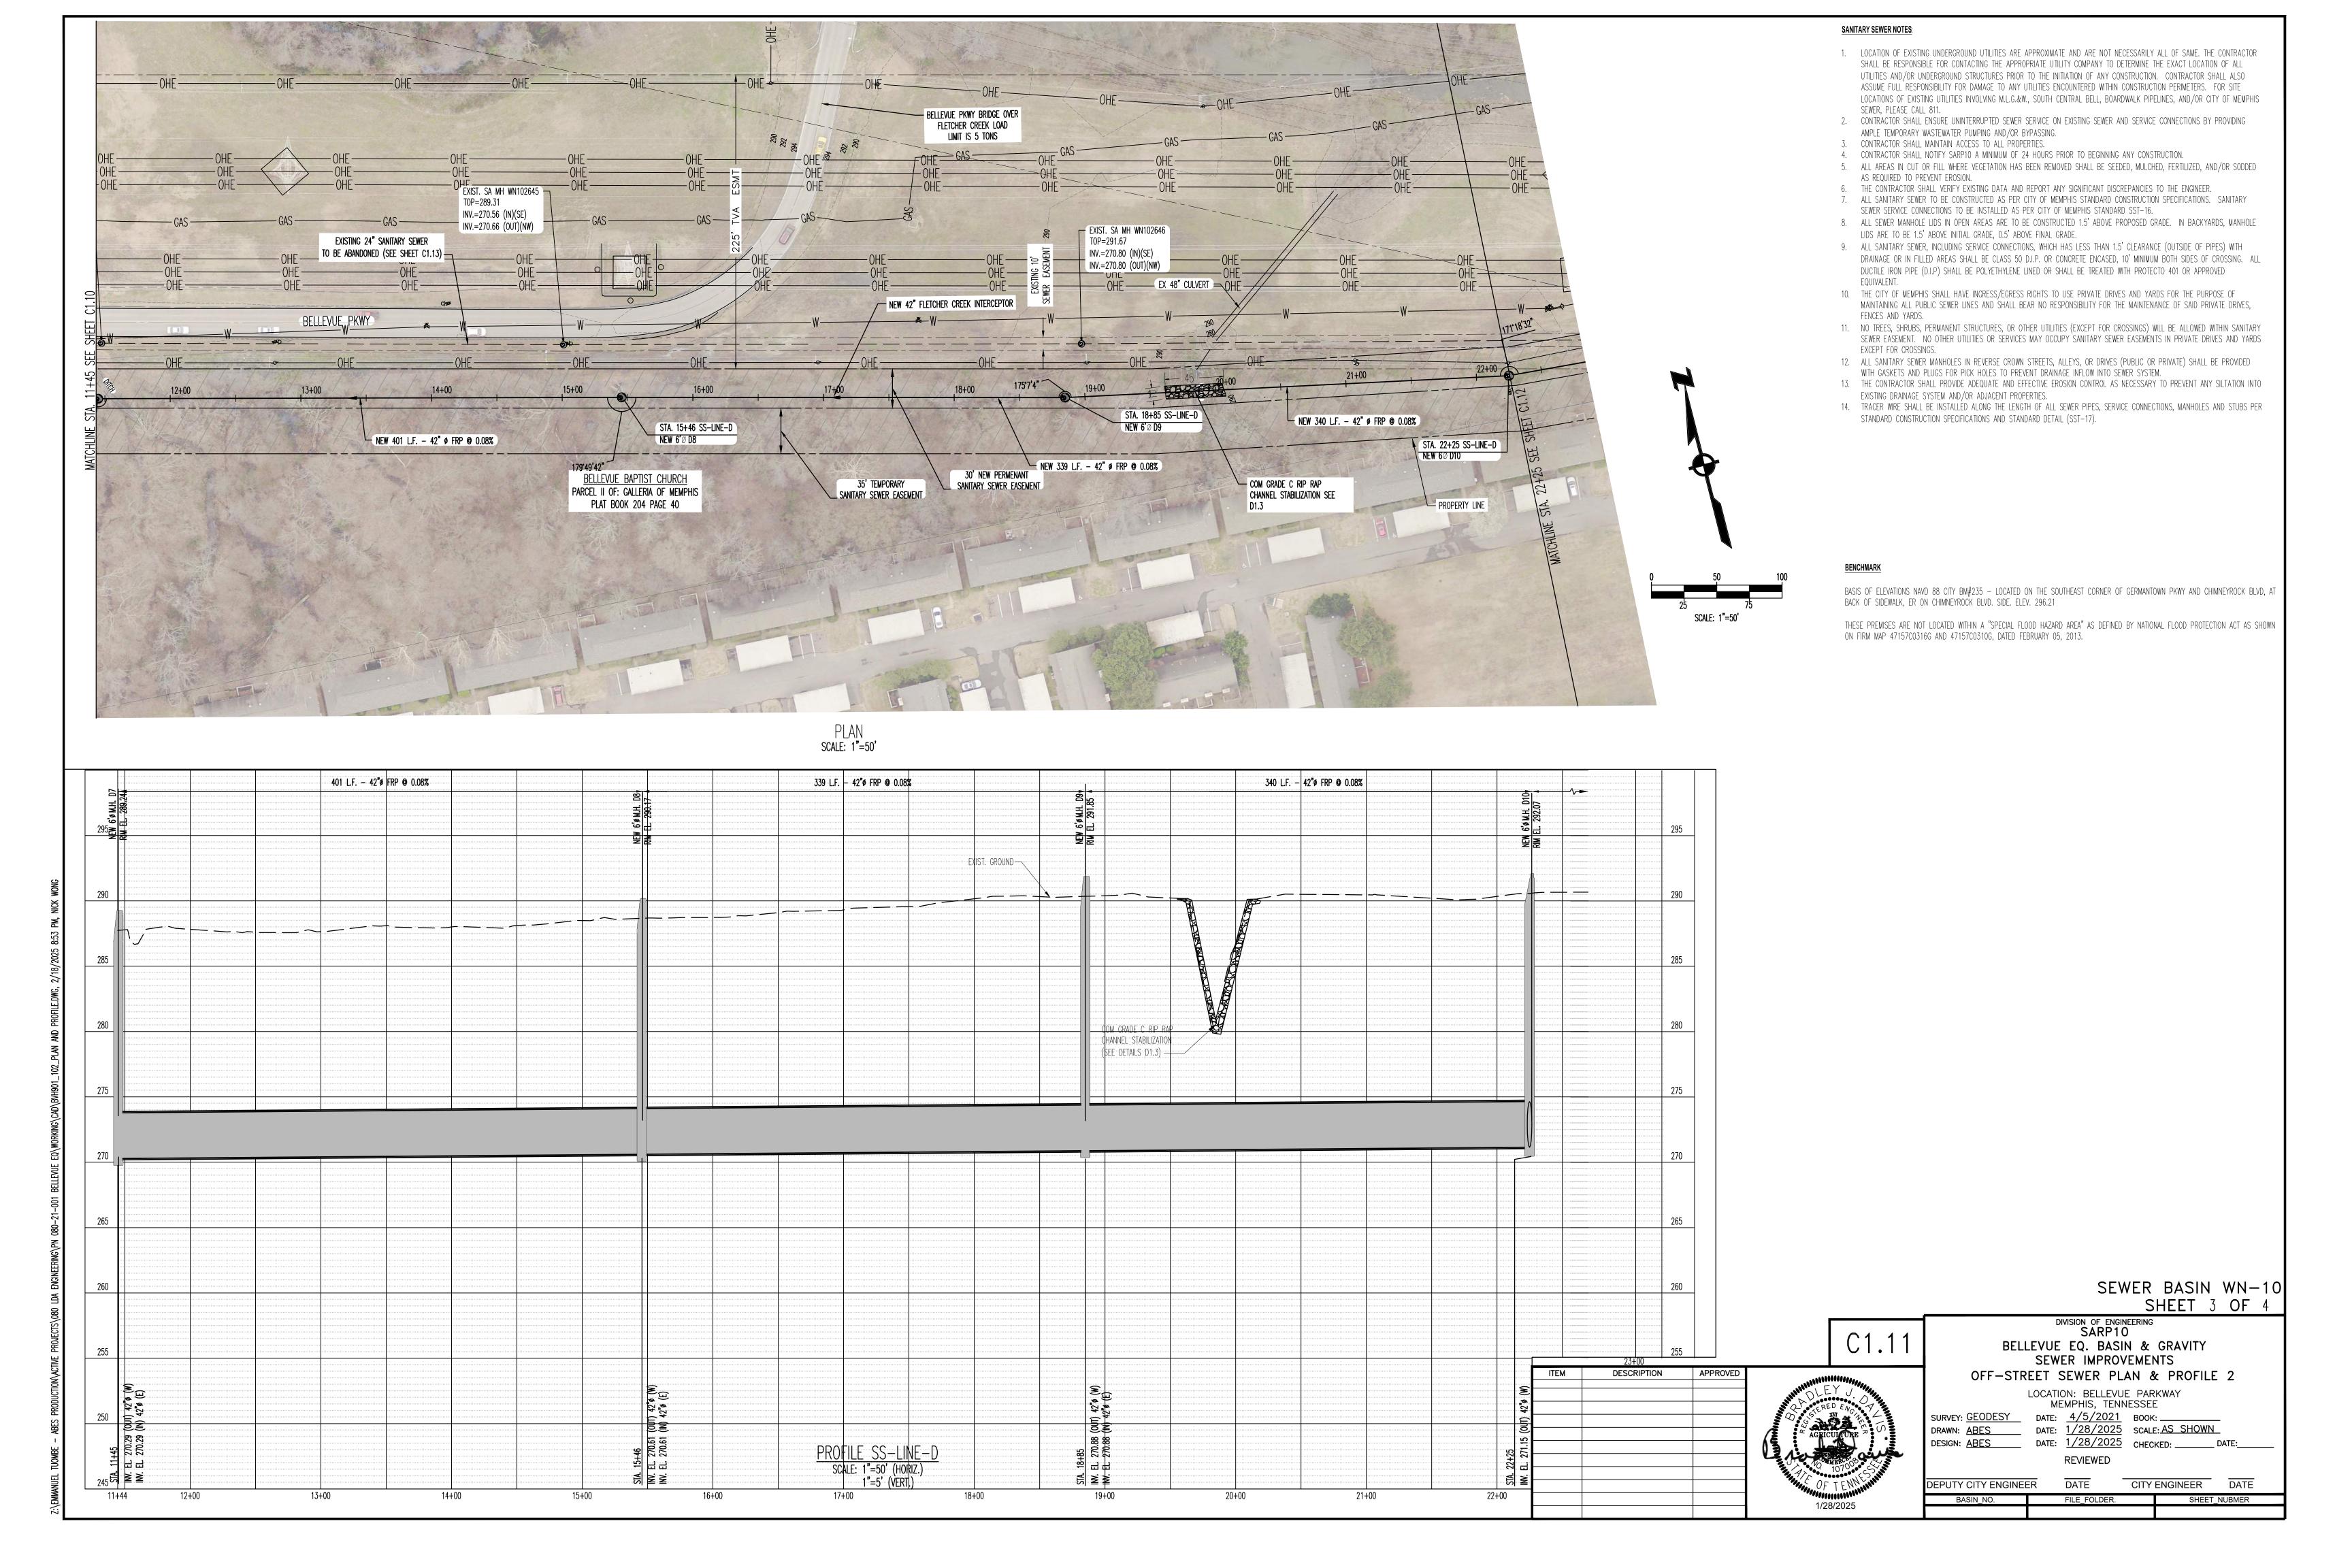
BENCHMARK

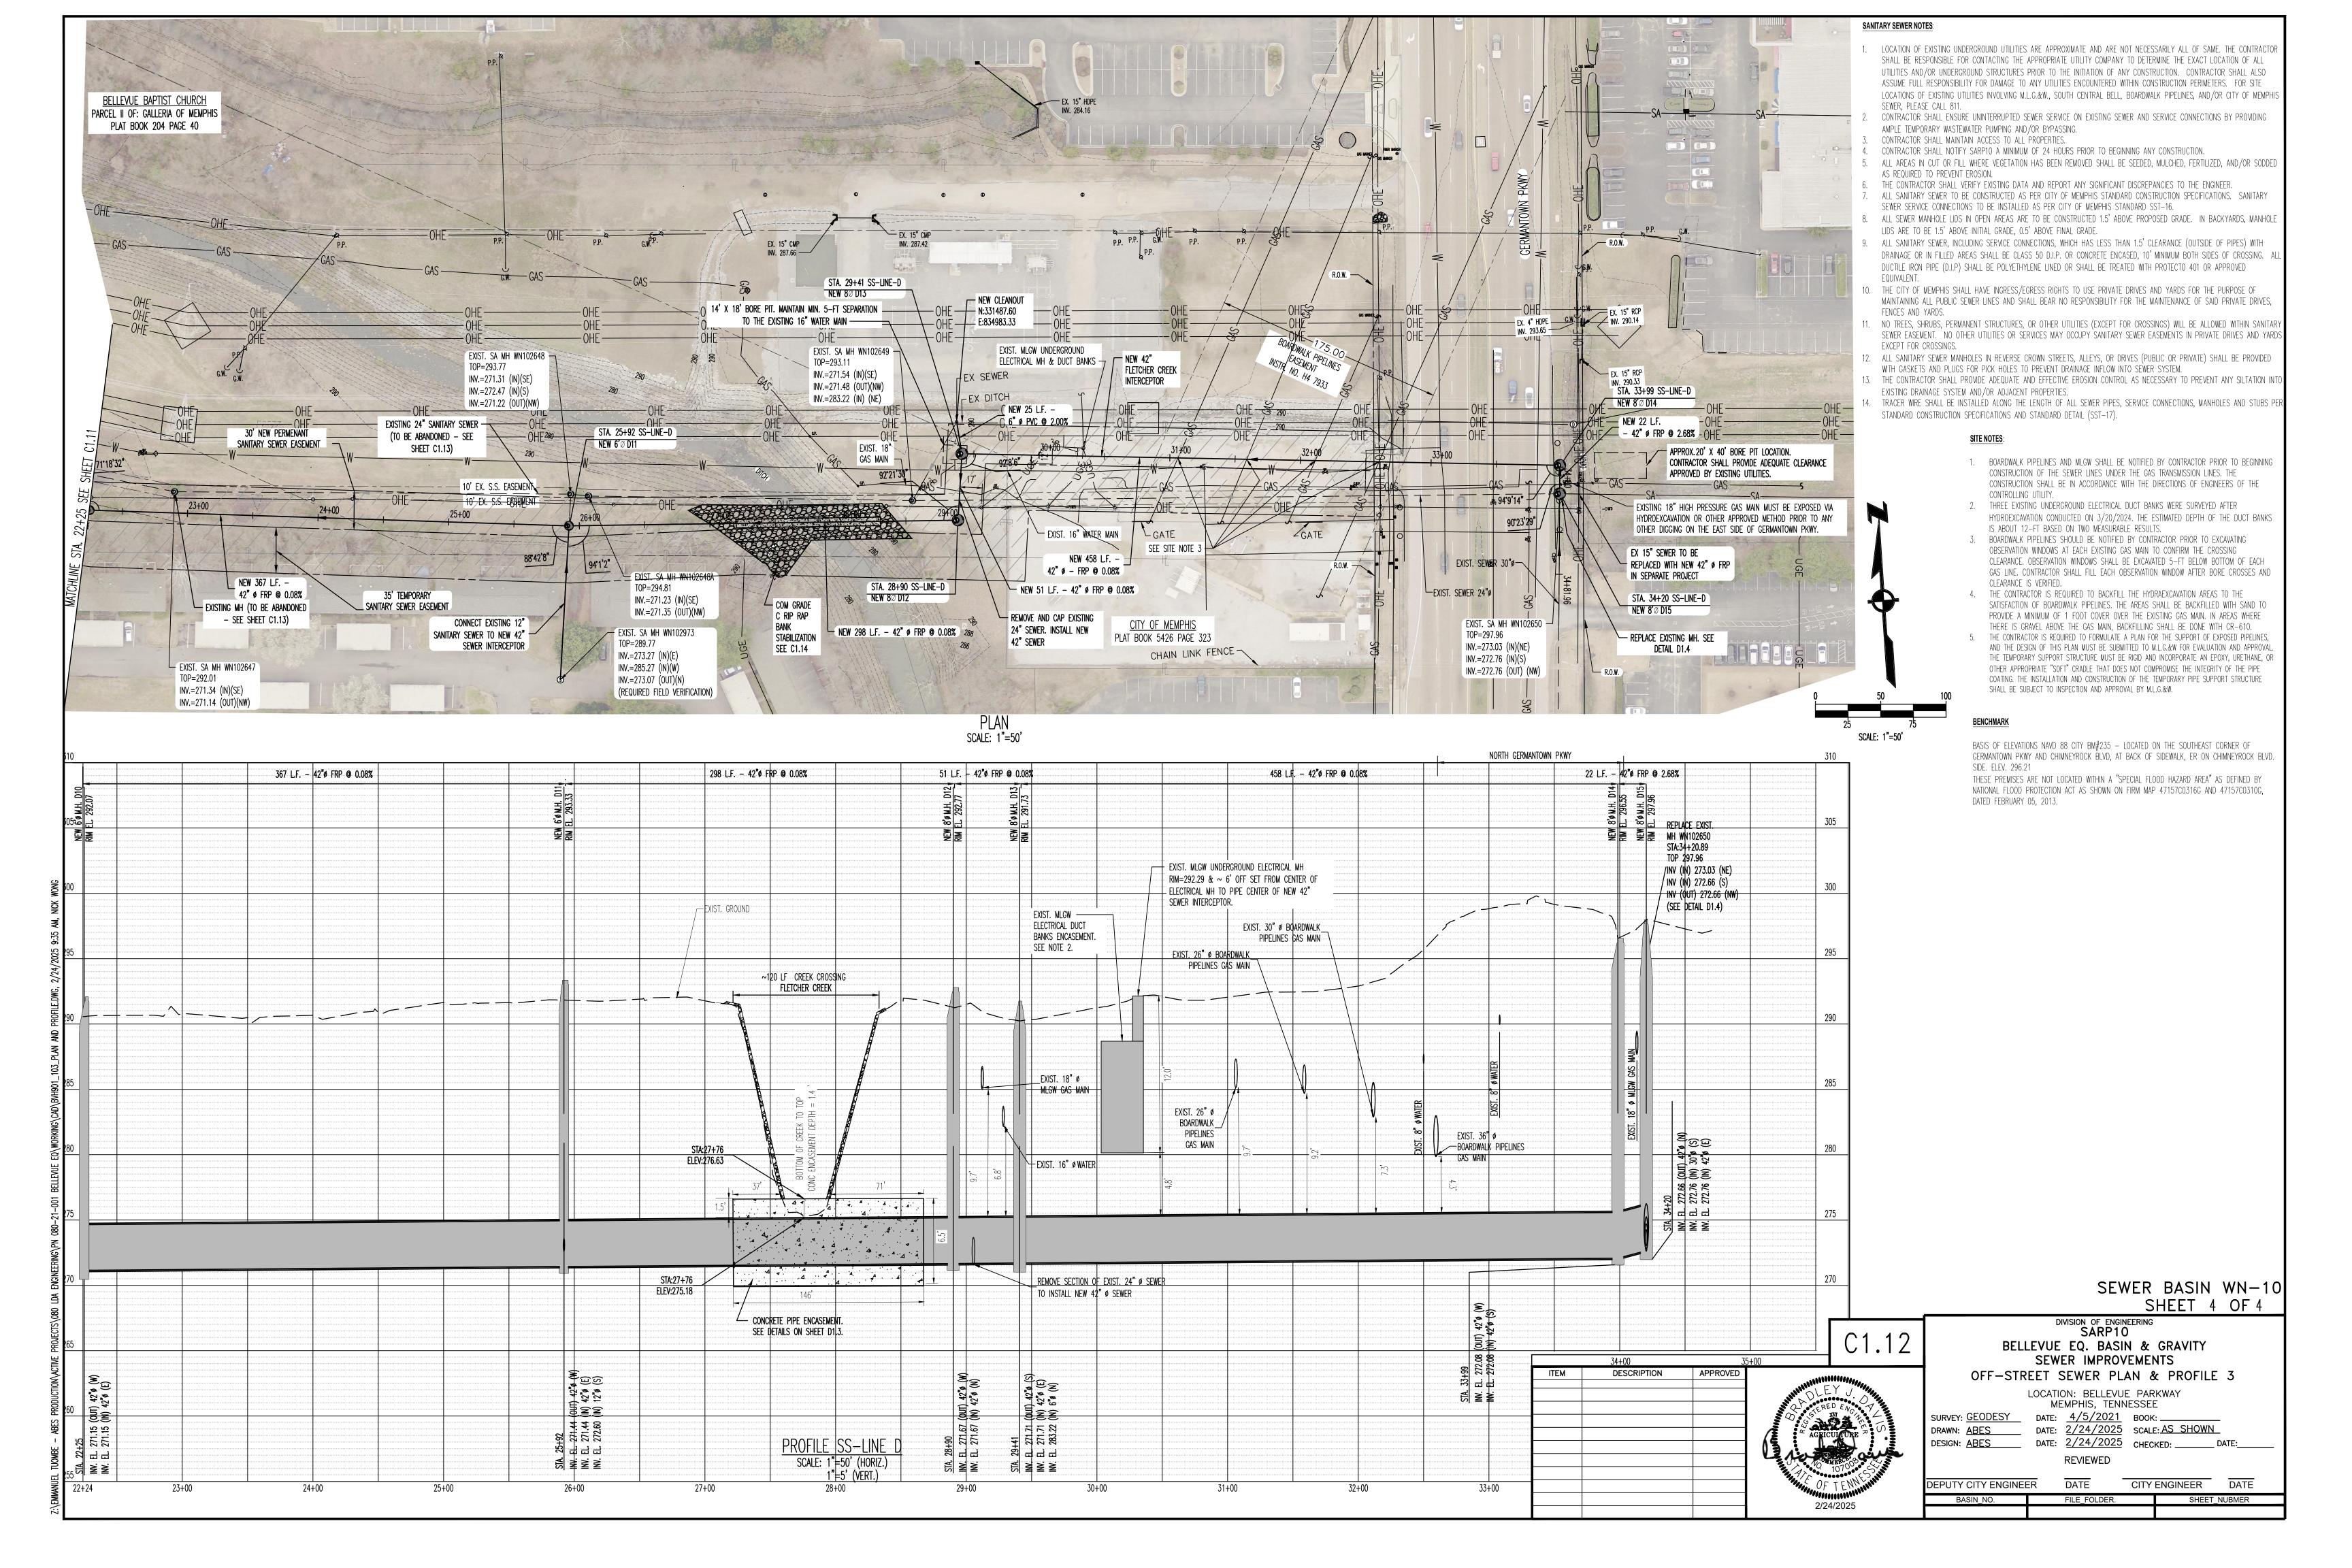BASIS OF ELEVATIONS NAVD 88 CITY BM#235 - LOCATED ON THE SOUTHEAST CORNER OF GERMANTOWN PKWY AND CHIMNEYROCK BLVD, AT BACK OF SIDEWALK, ER ON CHIMNEYROCK BLVD. SIDE. ELEV. 296.21

THESE PREMISES ARE NOT LOCATED WITHIN A "SPECIAL FLOOD HAZARD AREA" AS DEFINED BY NATIONAL FLOOD PROTECTION ACT AS SHOWN ON FIRM MAP 47157CO316G AND 47157CO310G, DATED FEBRUARY 05, 2013.

APPROVED

DESCRIPTION

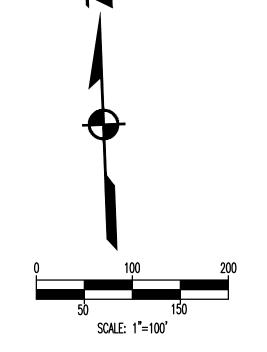

SEWER BASIN WN-10 SHEET 1 OF 1

DIVISION OF ENGINEERING SARP10 BELLEVUE EQ. BASIN & GRAVITY SEWER IMPROVEMENTS SEWER ABANDONMENT PLAN


LOCATION: BELLEVUE PARKWAY MEMPHIS, TENNESSEE


SURVEY: <u>GEODESY</u> DATE: <u>4/5/2021</u> BOOK: _____ DRAWN: ABES DATE: 1/28/2025 SCALE: AS SHOWN DESIGN: <u>ABES</u> DATE: <u>1/28/2025</u> CHECKED: _____ DATE: _____

REVIEWED

CITY ENGINEER DATE DATE DEPUTY CITY ENGINEER FILE FOLDER. SHEET_NUBMER BASIN NO.

1. SEE DETAILS ON SHEET D1.3 FOR ABANDONED SEWER MANHOLE.

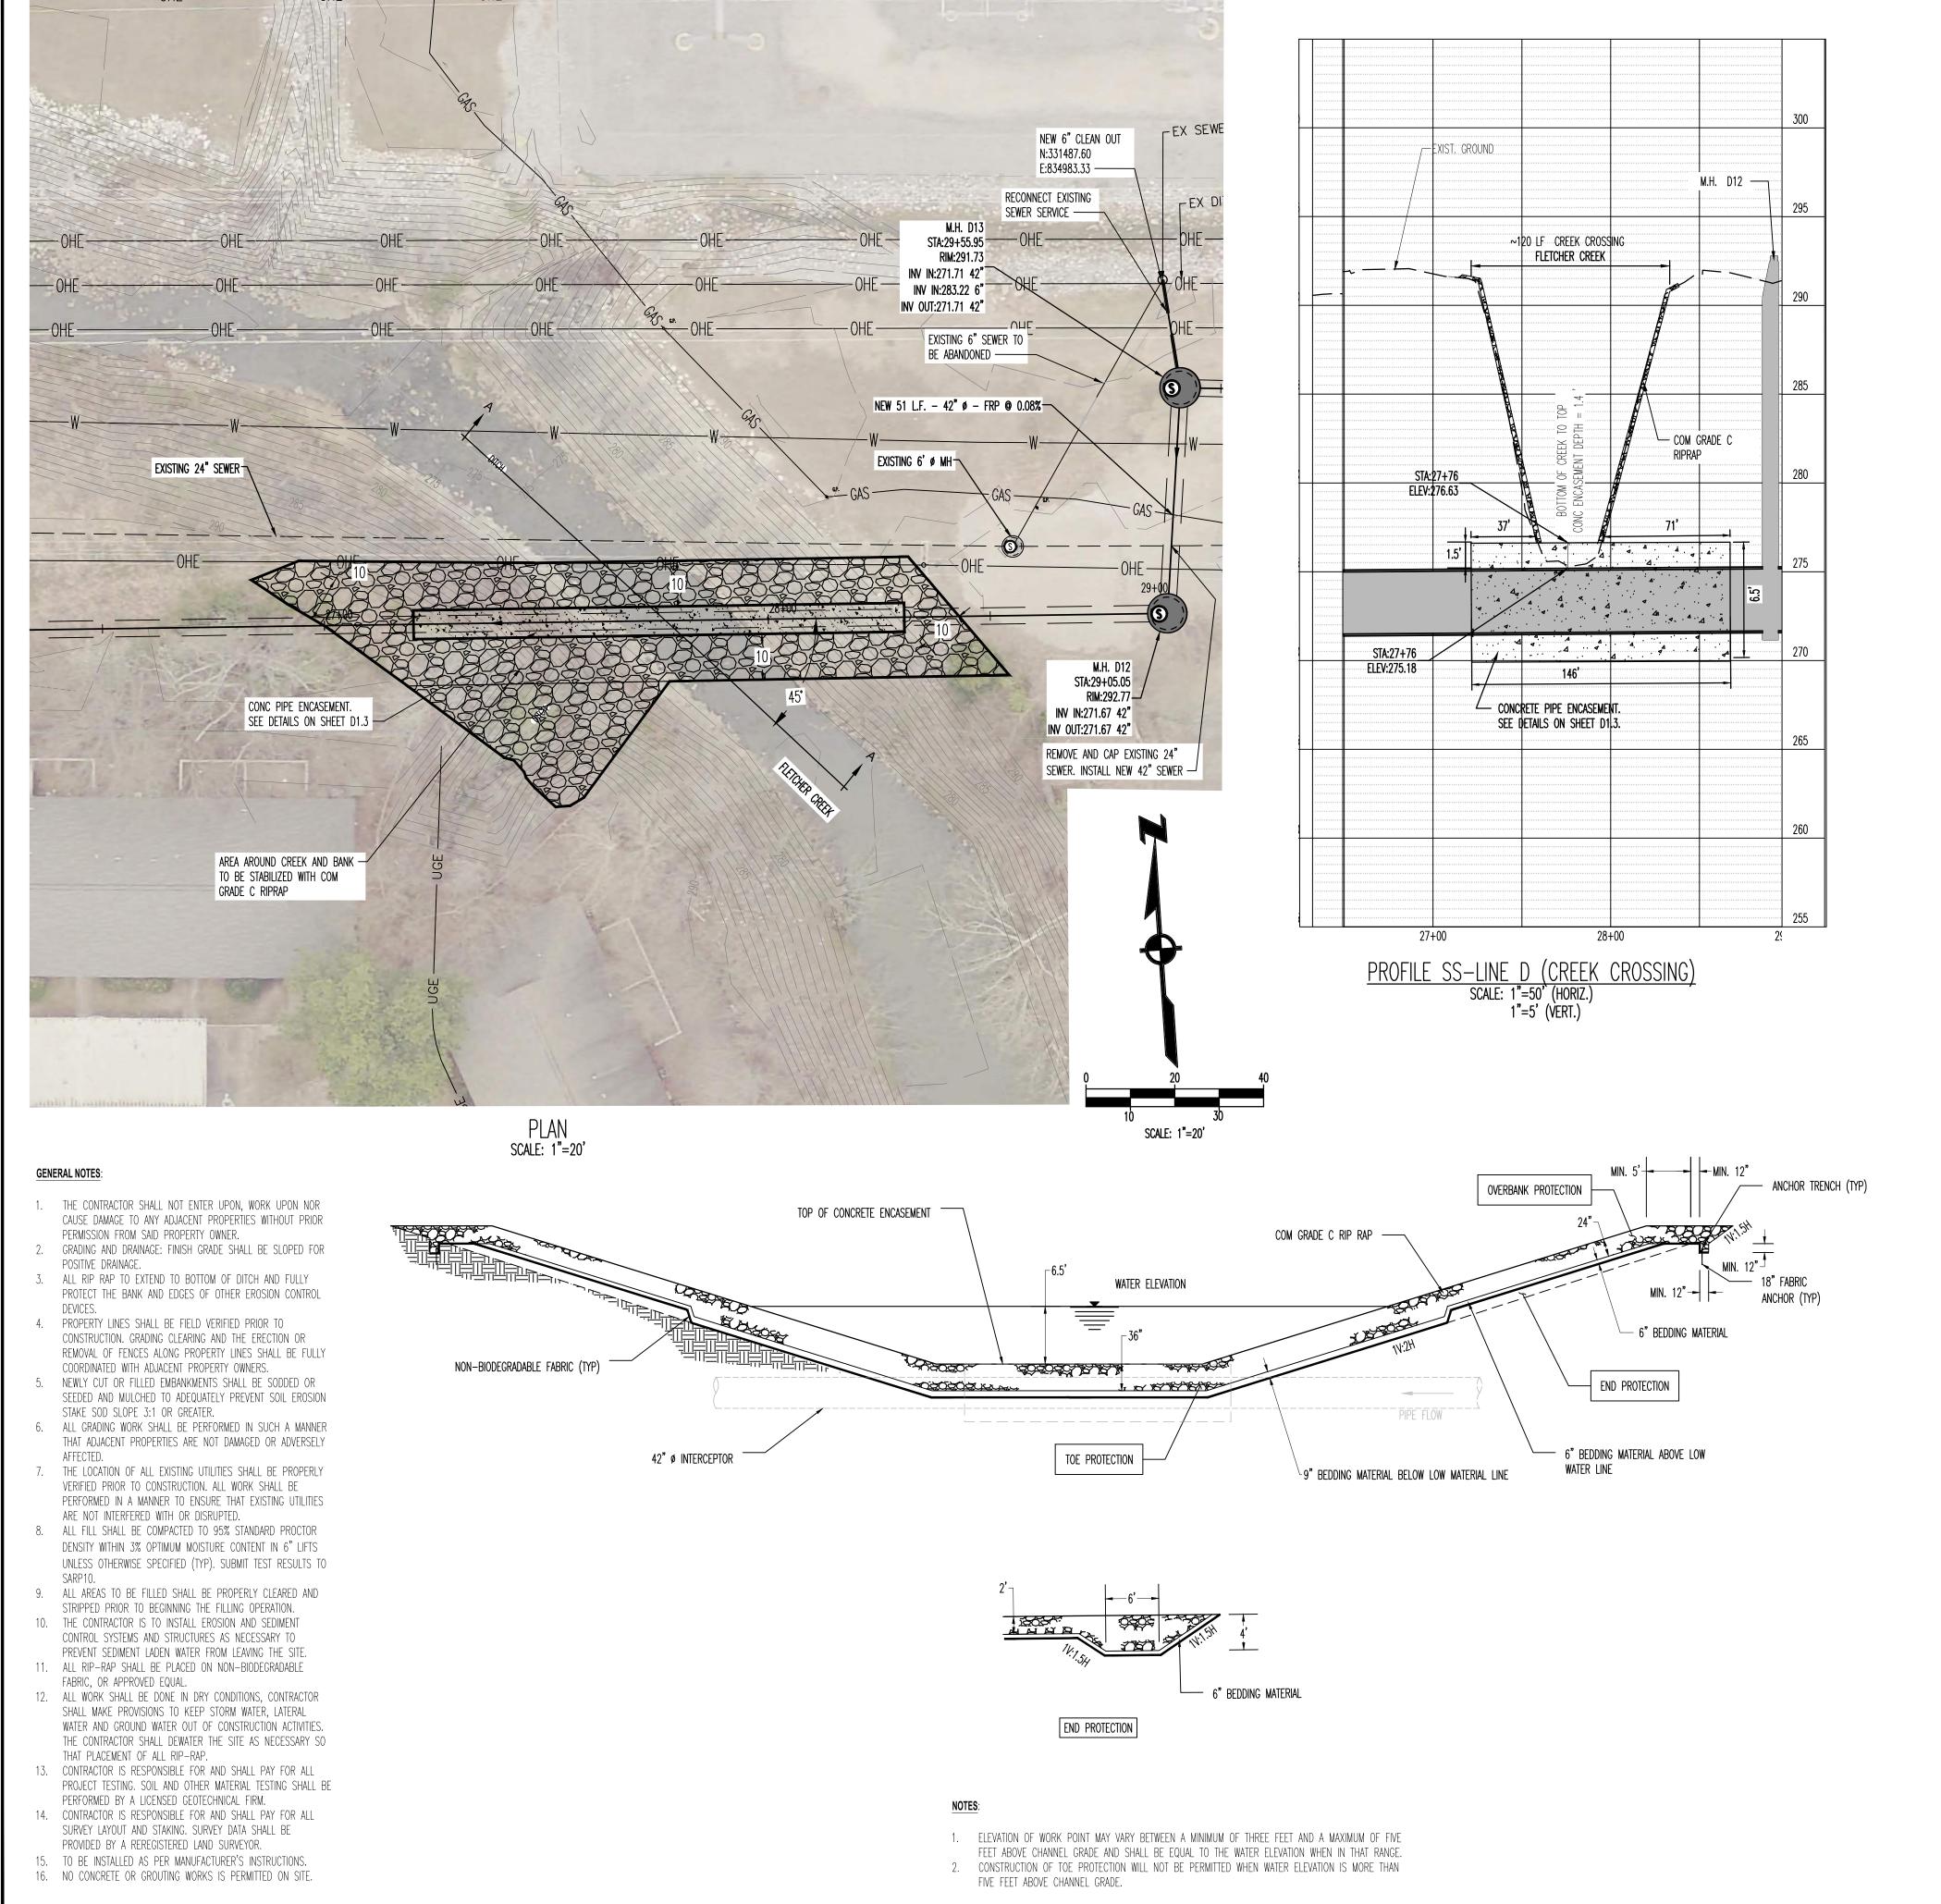

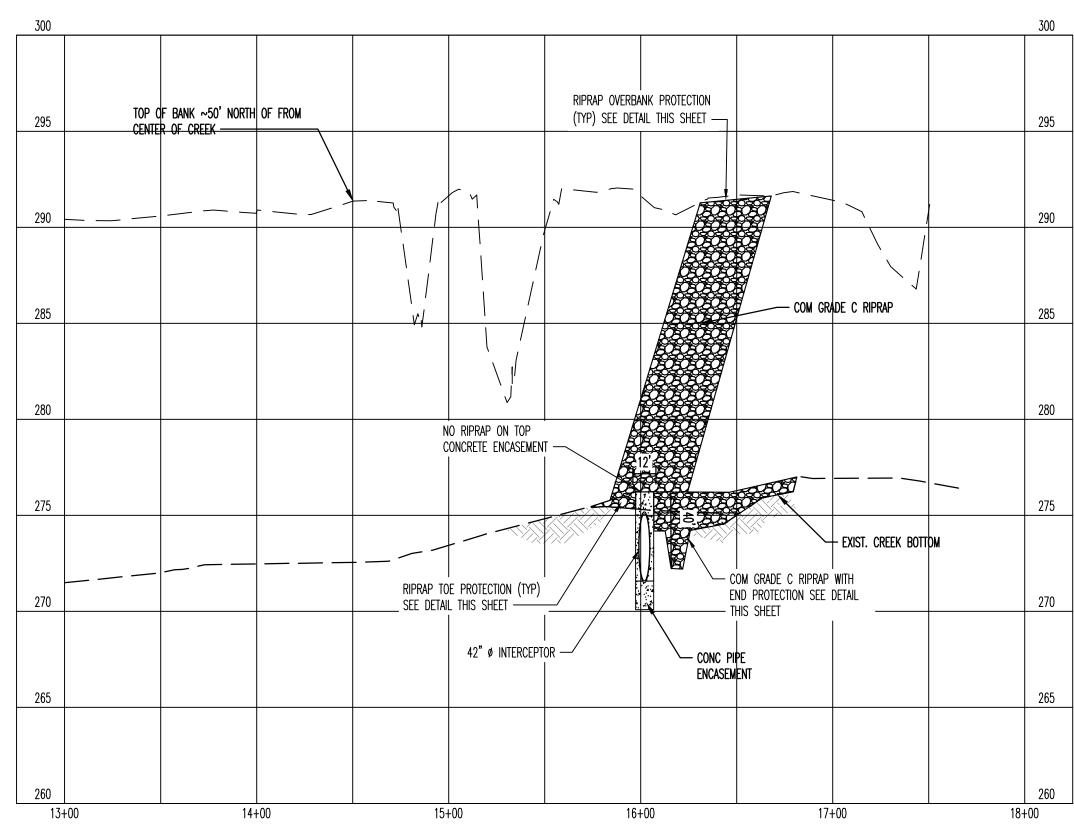

SECTION A-A

HORIZ: 1"=50' & VERTI: 1"=5'

SEWER BASIN WN-10 SHEET 1 OF 1

DIVISION OF ENGINEERING SARP10 BELLEVUE EQ. BASIN & GRAVITY SEWER IMPROVEMENTS BANK STABILIZATION PLAN


> LOCATION: BELLEVUE PARKWAY MEMPHIS, TENNESSEE SURVEY: <u>GEODESY</u> DATE: <u>4/5/2021</u> BOOK: ____


DRAWN: ABES DATE: 1/28/2025 SCALE: AS SHOWN DESIGN: <u>ABES</u> DATE: <u>1/28/2025</u> CHECKED: _____ DATE: REVIEWED


CITY ENGINEER DATE DATE DEPUTY CITY ENGINEER FILE_FOLDER. SHEET_NUBMER BASIN_NO.

DESCRIPTION APPROVED

RIPRAP TOE, END AND OVERBANK PROTECTION DETAILS SCALE: 1" = 10'

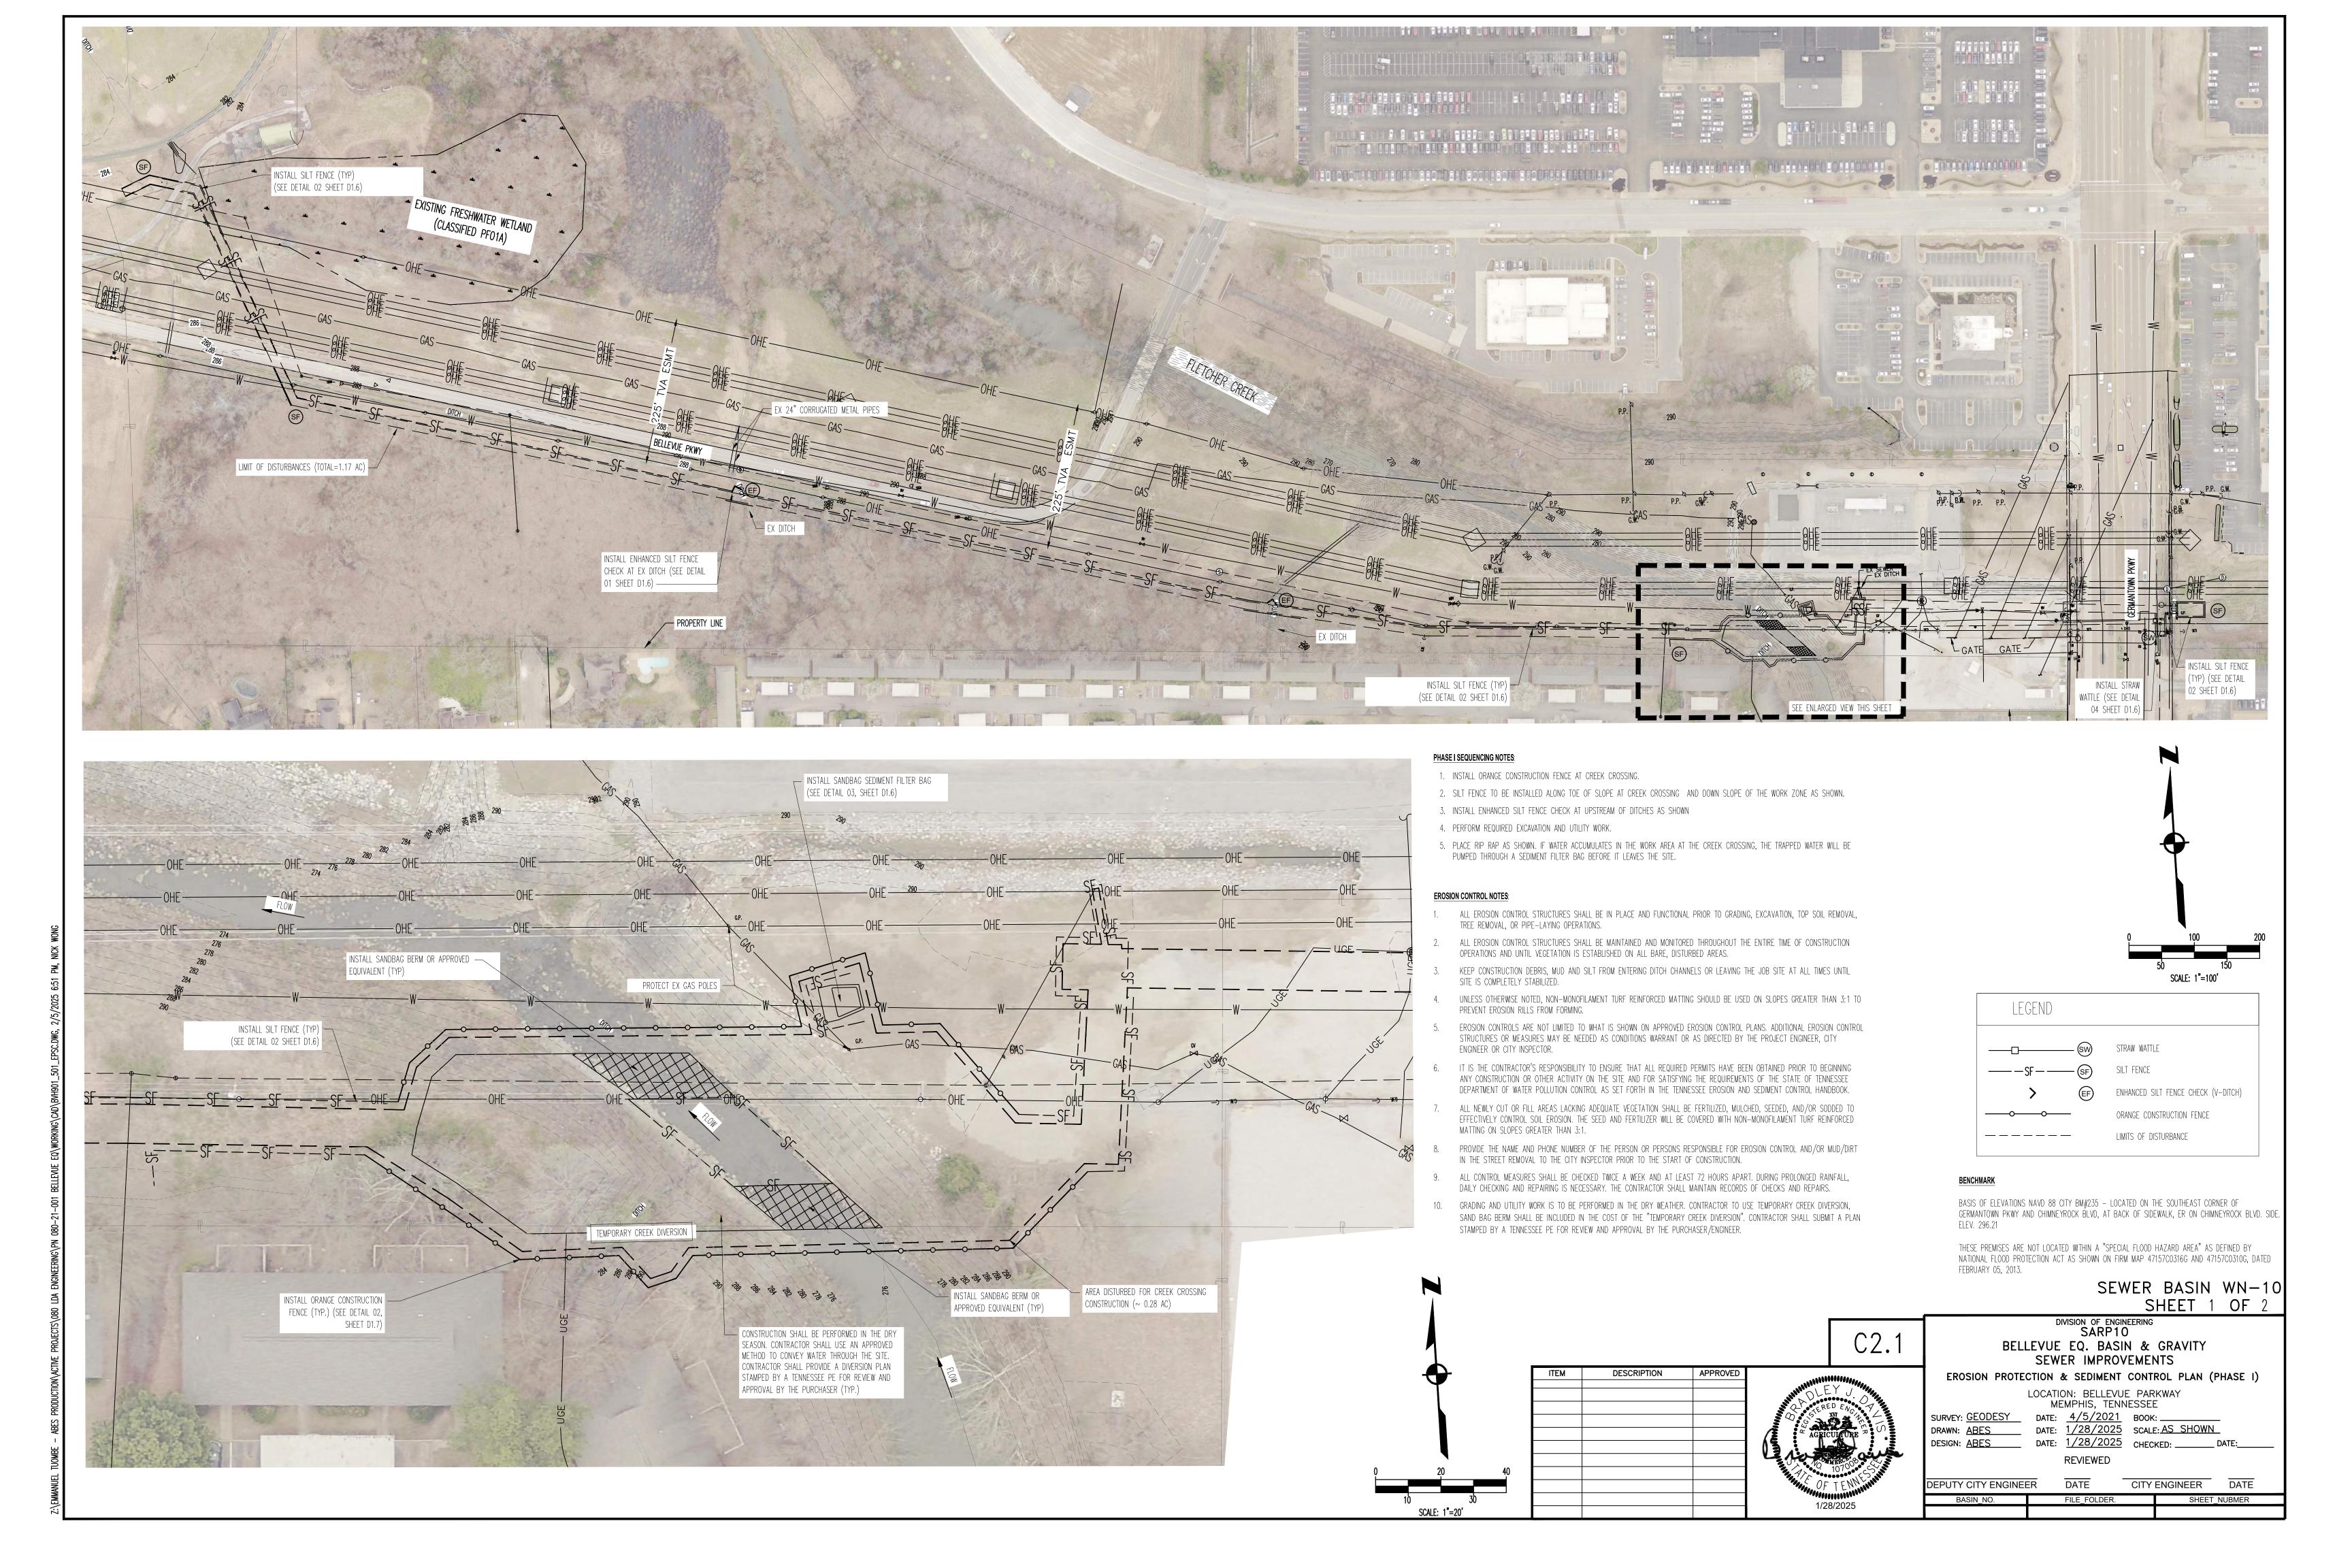


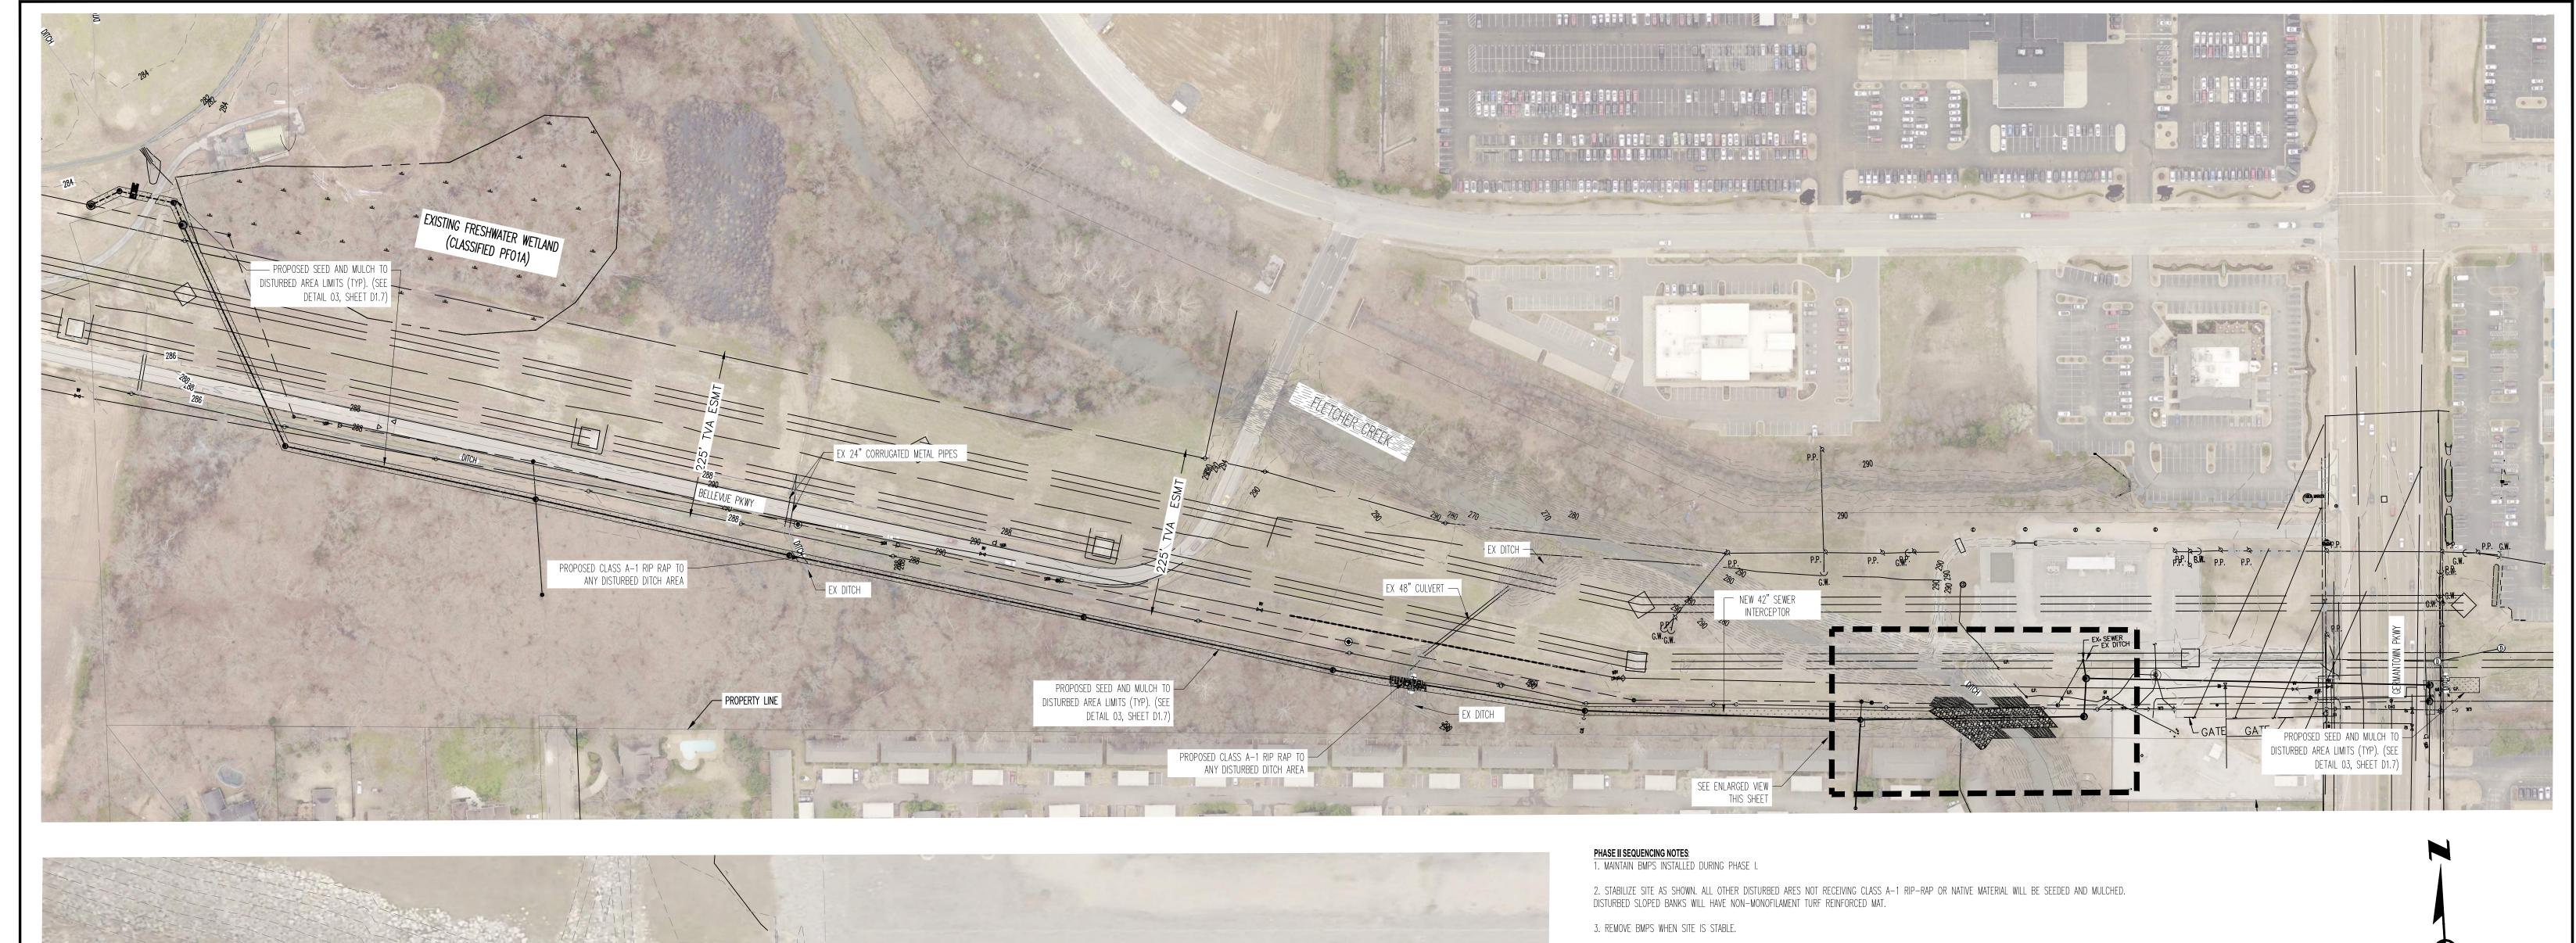

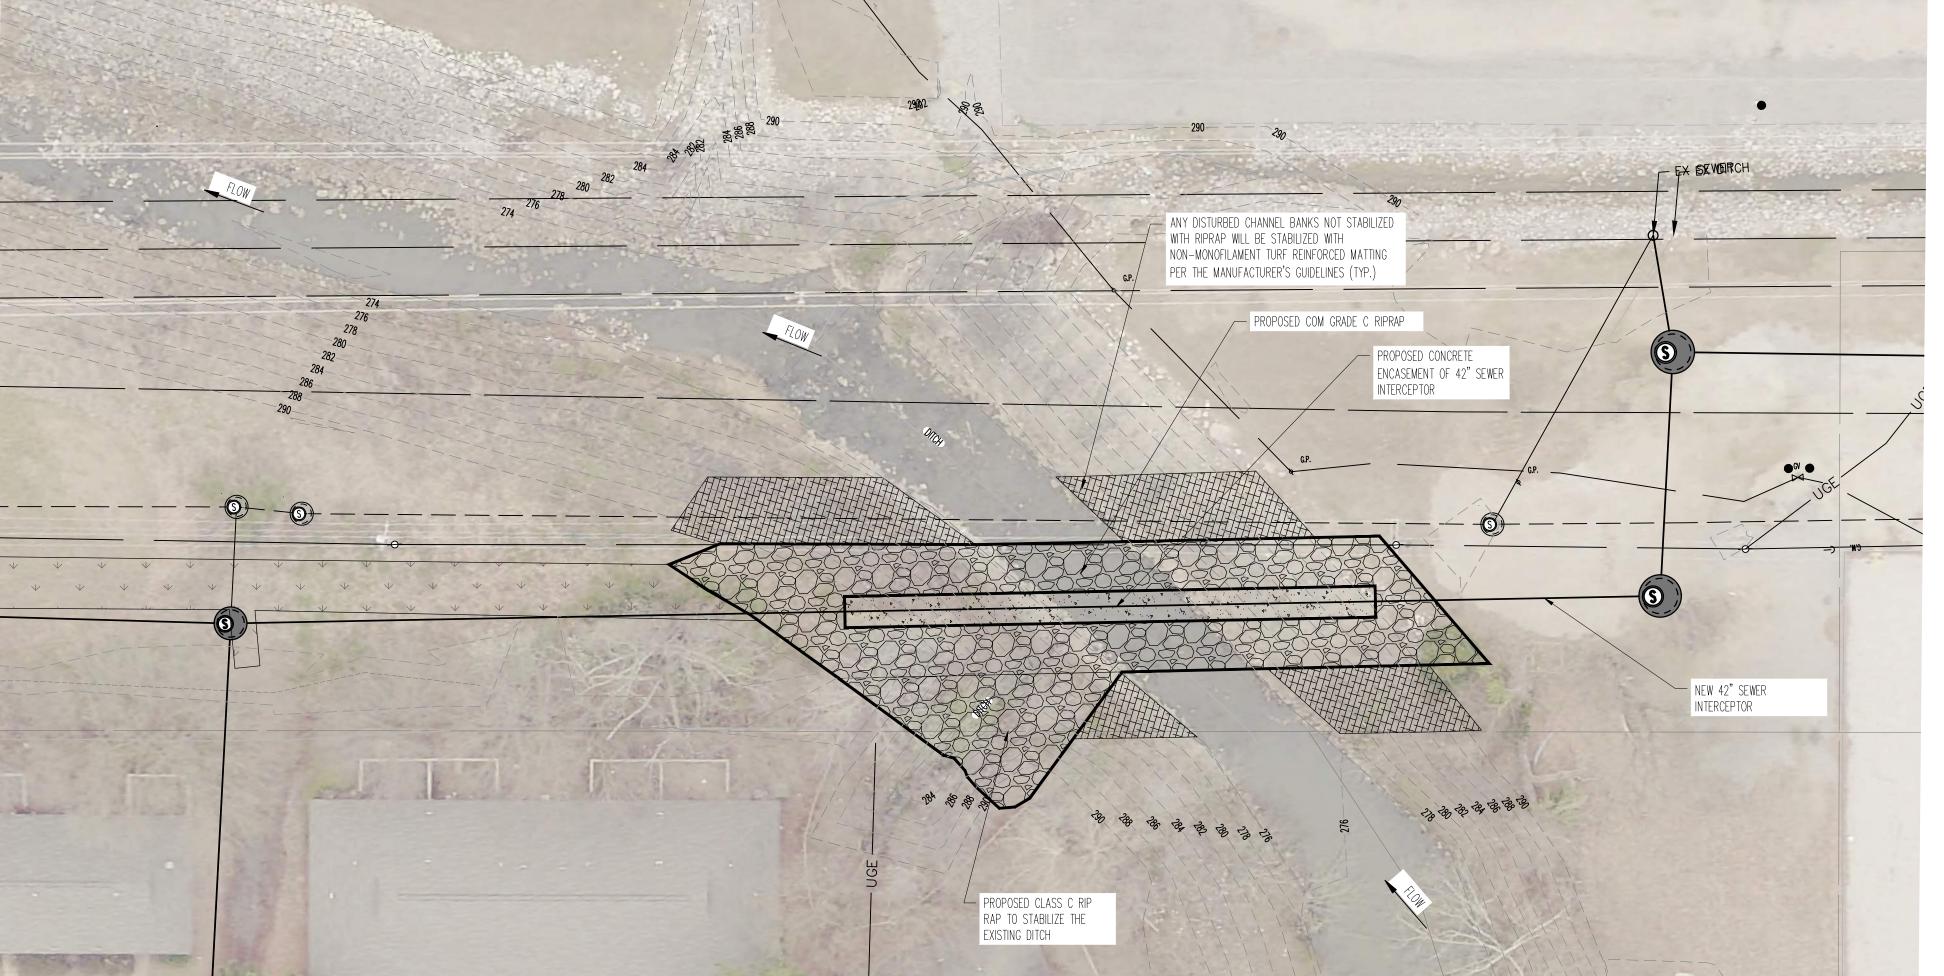

EROSION CONTROL NOTES:

- 1. ALL EROSION CONTROL STRUCTURES SHALL BE IN PLACE AND FUNCTIONAL PRIOR TO GRADING, EXCAVATION, TOP SOIL REMOVAL, TREE REMOVAL, OR PIPE-LAYING OPERATIONS.
- ALL EROSION CONTROL STRUCTURES SHALL BE MAINTAINED AND MONITORED THROUGHOUT THE ENTIRE TIME OF CONSTRUCTION OPERATIONS AND UNTIL VEGETATION IS ESTABLISHED ON ALL BARE, DISTURBED AREAS.
- 3. KEEP CONSTRUCTION DEBRIS, MUD AND SILT FROM ENTERING DITCH CHANNELS OR LEAVING THE JOB SITE AT ALL TIMES UNTIL
- SITE IS COMPLETELY STABILIZED.
- 4. UNLESS OTHERWISE NOTED, NON-MONOFILAMENT TURF REINFORCED MATTING SHOULD BE USED ON SLOPES GREATER THAN 3:1 TO PREVENT EROSION RILLS FROM FORMING.
- 5. EROSION CONTROLS ARE NOT LIMITED TO WHAT IS SHOWN ON APPROVED EROSION CONTROL PLANS. ADDITIONAL EROSION CONTROL STRUCTURES OR MEASURES MAY BE NEEDED AS CONDITIONS WARRANT OR AS DIRECTED BY THE PROJECT ENGINEER, CITY ENGINEER OR CITY INSPECTOR.
- IT IS THE CONTRACTOR'S RESPONSIBILITY TO ENSURE THAT ALL REQUIRED PERMITS HAVE BEEN OBTAINED PRIOR TO BEGINNING ANY CONSTRUCTION OR OTHER ACTIVITY ON THE SITE AND FOR SATISFYING THE REQUIREMENTS OF THE STATE OF TENNESSEE DEPARTMENT OF WATER POLLUTION CONTROL AS SET FORTH IN THE TENNESSEE EROSION AND SEDIMENT CONTROL HANDBOOK.
- ALL NEWLY CUT OR FILL AREAS LACKING ADEQUATE VEGETATION SHALL BE FERTILIZED, MULCHED, SEEDED, AND/OR SODDED TO EFFECTIVELY CONTROL SOIL EROSION. THE SEED AND FERTILIZER WILL BE COVERED WITH NON-MONOFILAMENT TÜRF REINFORCED MATTING ON SLOPES GREATER THAN 3:1.
- PROVIDE THE NAME AND PHONE NUMBER OF THE PERSON OR PERSONS RESPONSIBLE FOR EROSION CONTROL AND/OR MUD/DIRT IN THE STREET REMOVAL TO THE CITY INSPECTOR PRIOR TO THE START OF CONSTRUCTION.
- ALL CONTROL MEASURES SHALL BE CHECKED TWICE A WEEK AND AT LEAST 72 HOURS APART. DURING PROLONGED RAINFALL, DAILY CHECKING AND REPAIRING IS NECESSARY. THE CONTRACTOR SHALL MAINTAIN RECORDS OF CHECKS AND REPAIRS.
- 10. GRADING AND UTILITY WORK IS TO BE PERFORMED IN THE DRY WEATHER. CONTRACTOR TO USE TEMPORARY CREEK DIVERSION, SAND BAG BERM SHALL BE INCLUDED IN THE COST OF THE "TEMPORARY CREEK DIVERSION". CONTRACTOR SHALL SUBMIT A PLAN STAMPED BY A TENNESSEE PE FOR REVIEW AND APPROVAL BY THE PURCHASER/ENGINEER.

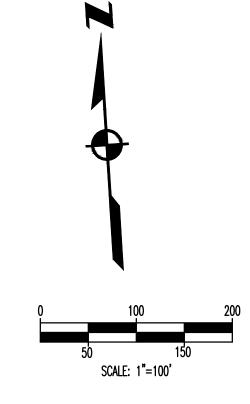

LEGEND

SEED AND MULCH AREA

NON-MONOFILAMENT TURF REINFORCED MATTING

CLASS C RIP RAP

BENCHMARK

BASIS OF ELEVATIONS NAVD 88 CITY BM#235 - LOCATED ON THE SOUTHEAST CORNER OF GERMANTOWN PKWY AND CHIMNEYROCK BLVD, AT BACK OF SIDEWALK, ER ON CHIMNEYROCK BLVD. SIDE. ELEV. 296.21

THESE PREMISES ARE NOT LOCATED WITHIN A "SPECIAL FLOOD HAZARD AREA" AS DEFINED BY NATIONAL FLOOD PROTECTION ACT AS SHOWN ON FIRM MAP 47157C0316G AND 47157C0310G, DATED FEBRUARY 05, 2013.

SEWER BASIN WN-10

SHEET 2 OF 2 DIVISION OF ENGINEERING SARP10 BELLEVUE EQ. BASIN & GRAVITY

SEWER IMPROVEMENTS EROSION PROTECTION & SEDIMENT CONTROL PLAN (PHASE II)


LOCATION: BELLEVUE PARKWAY MEMPHIS, TENNESSEE


SURVEY: <u>GEODESY</u> DATE: <u>4/5/2021</u> BOOK: _____


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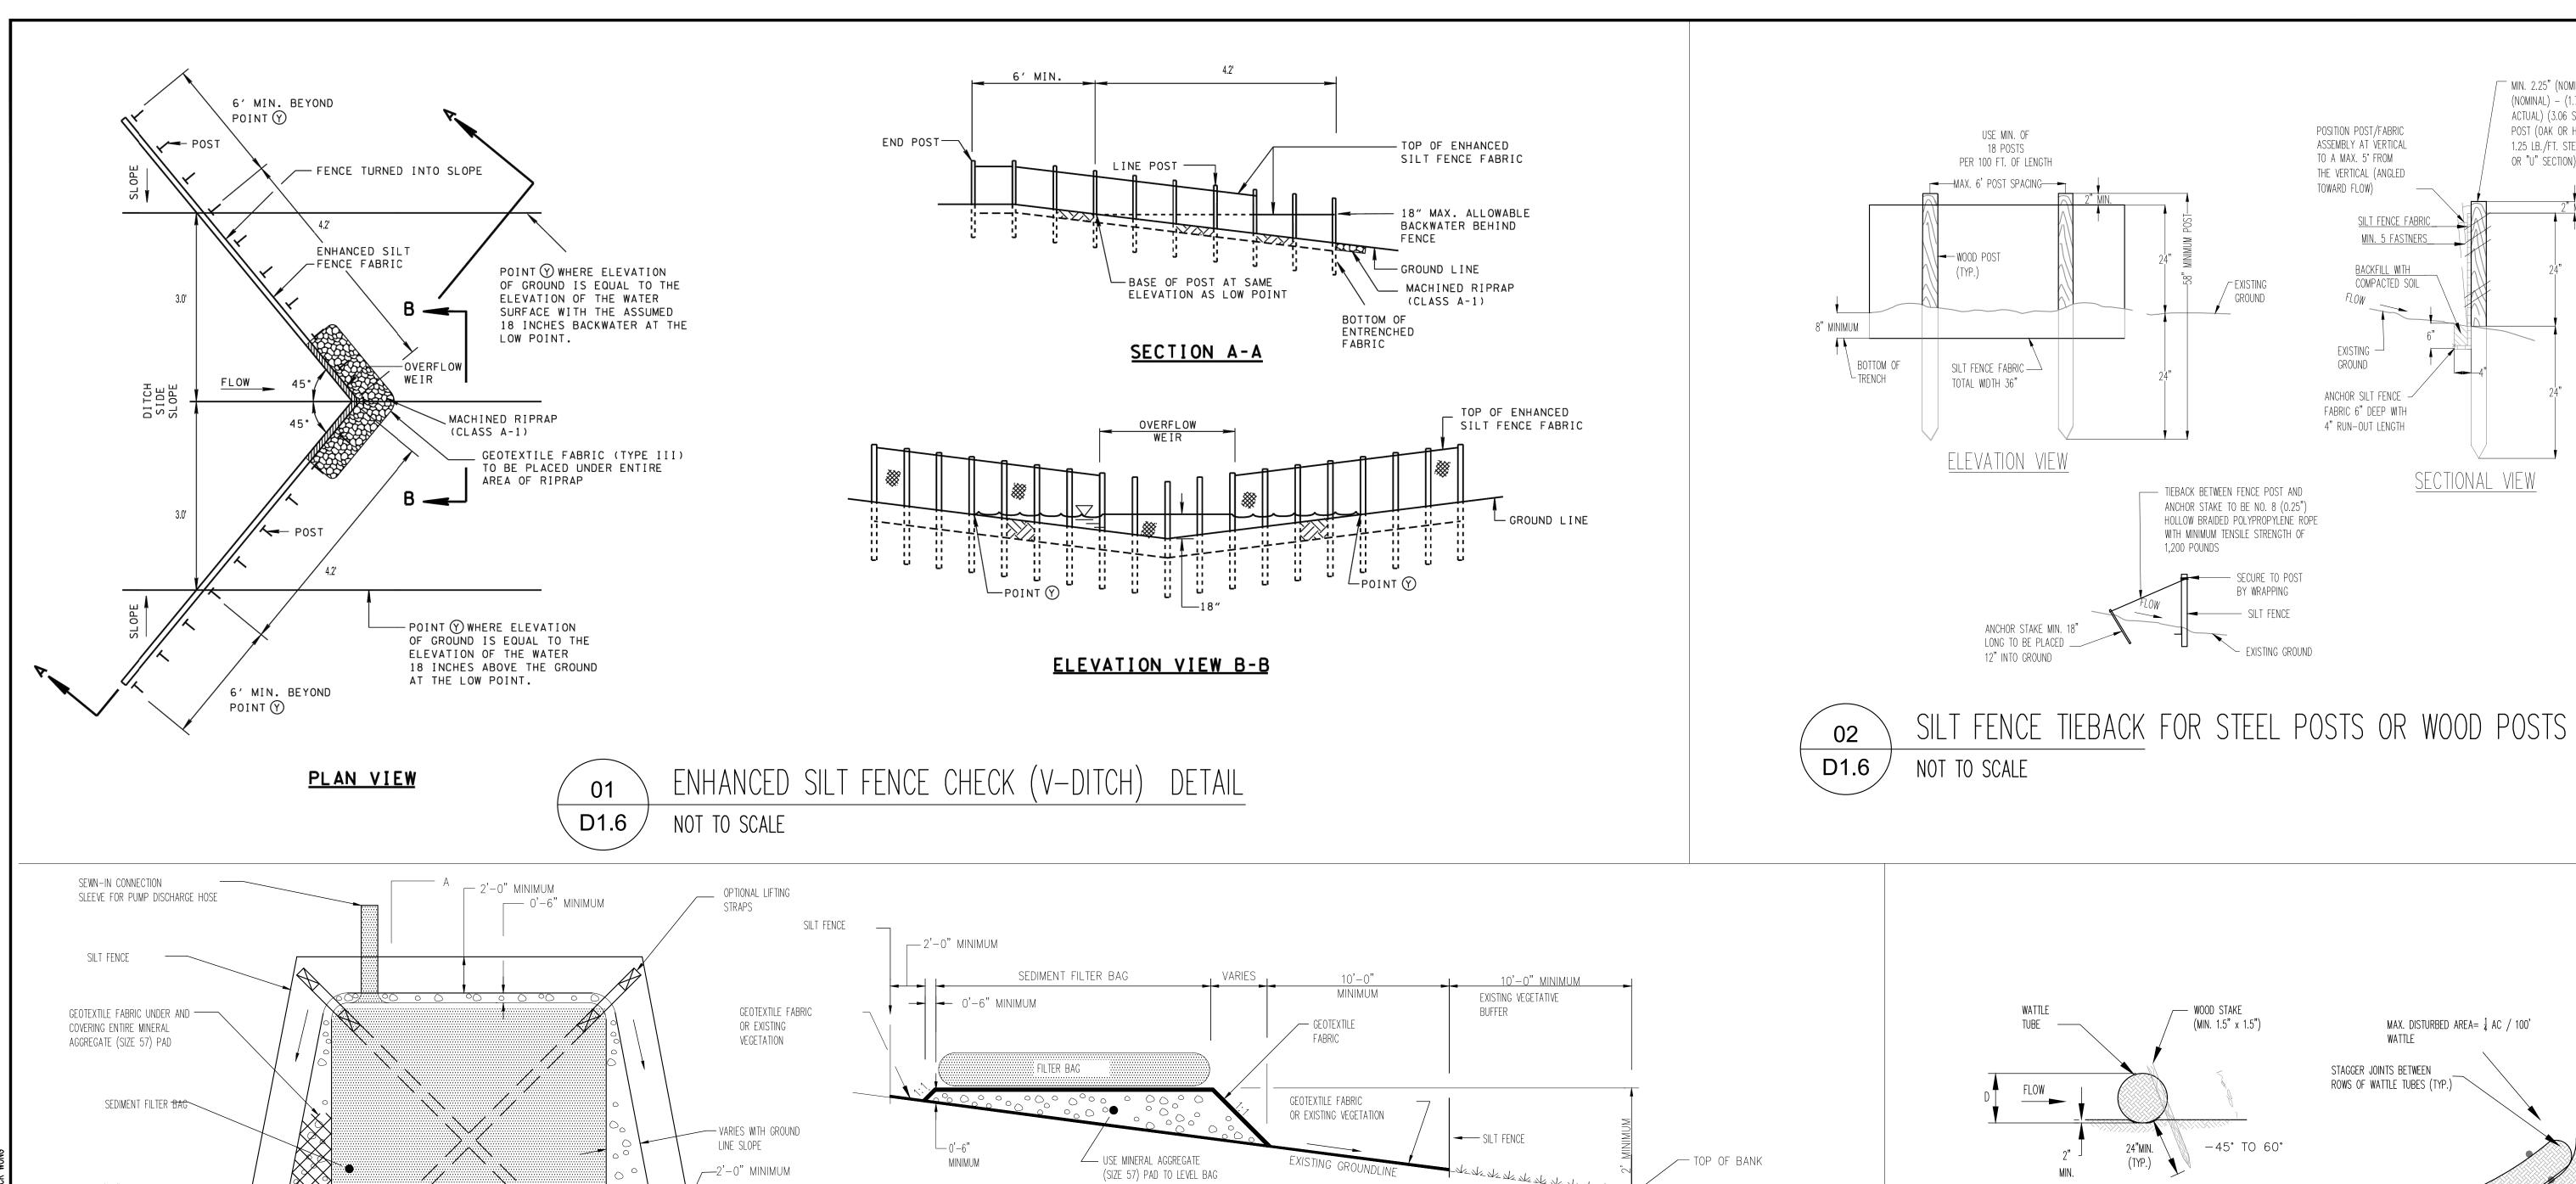
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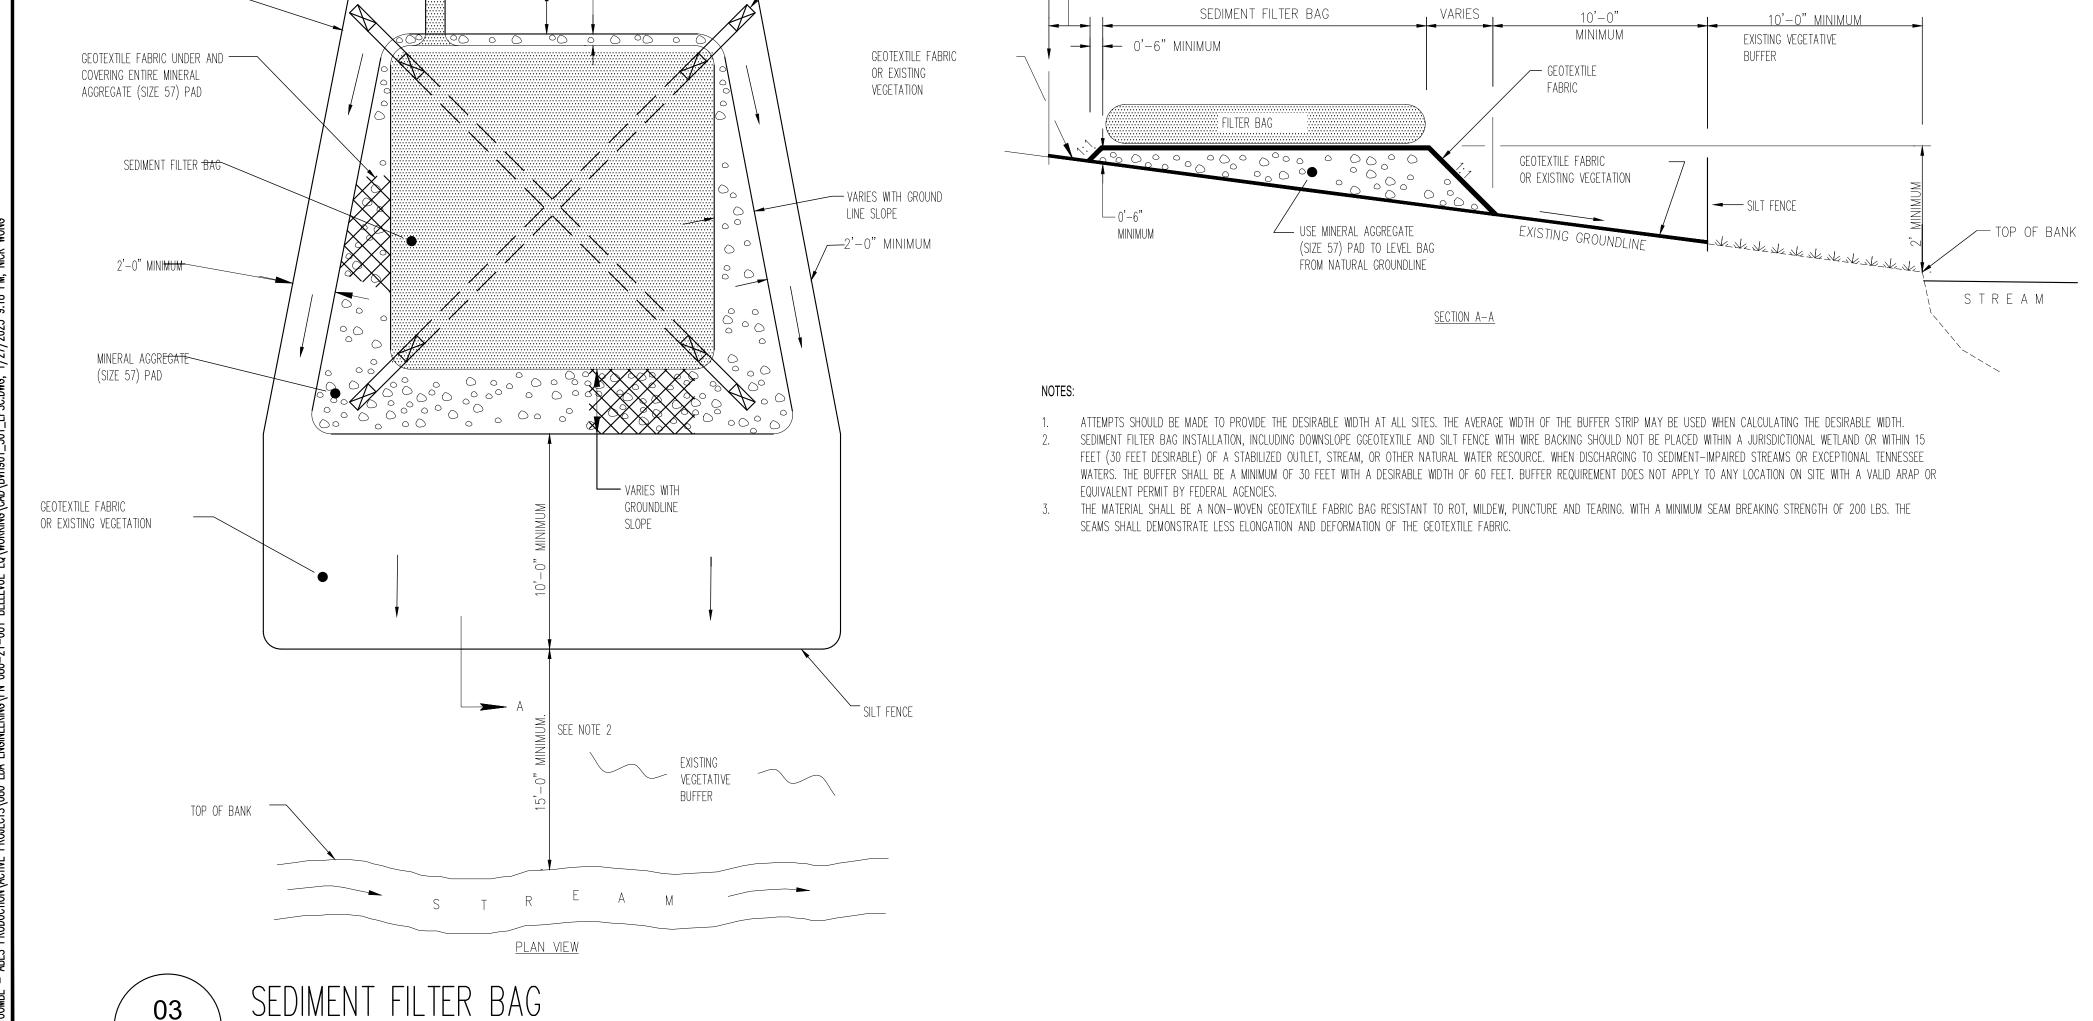
DESCRIPTION





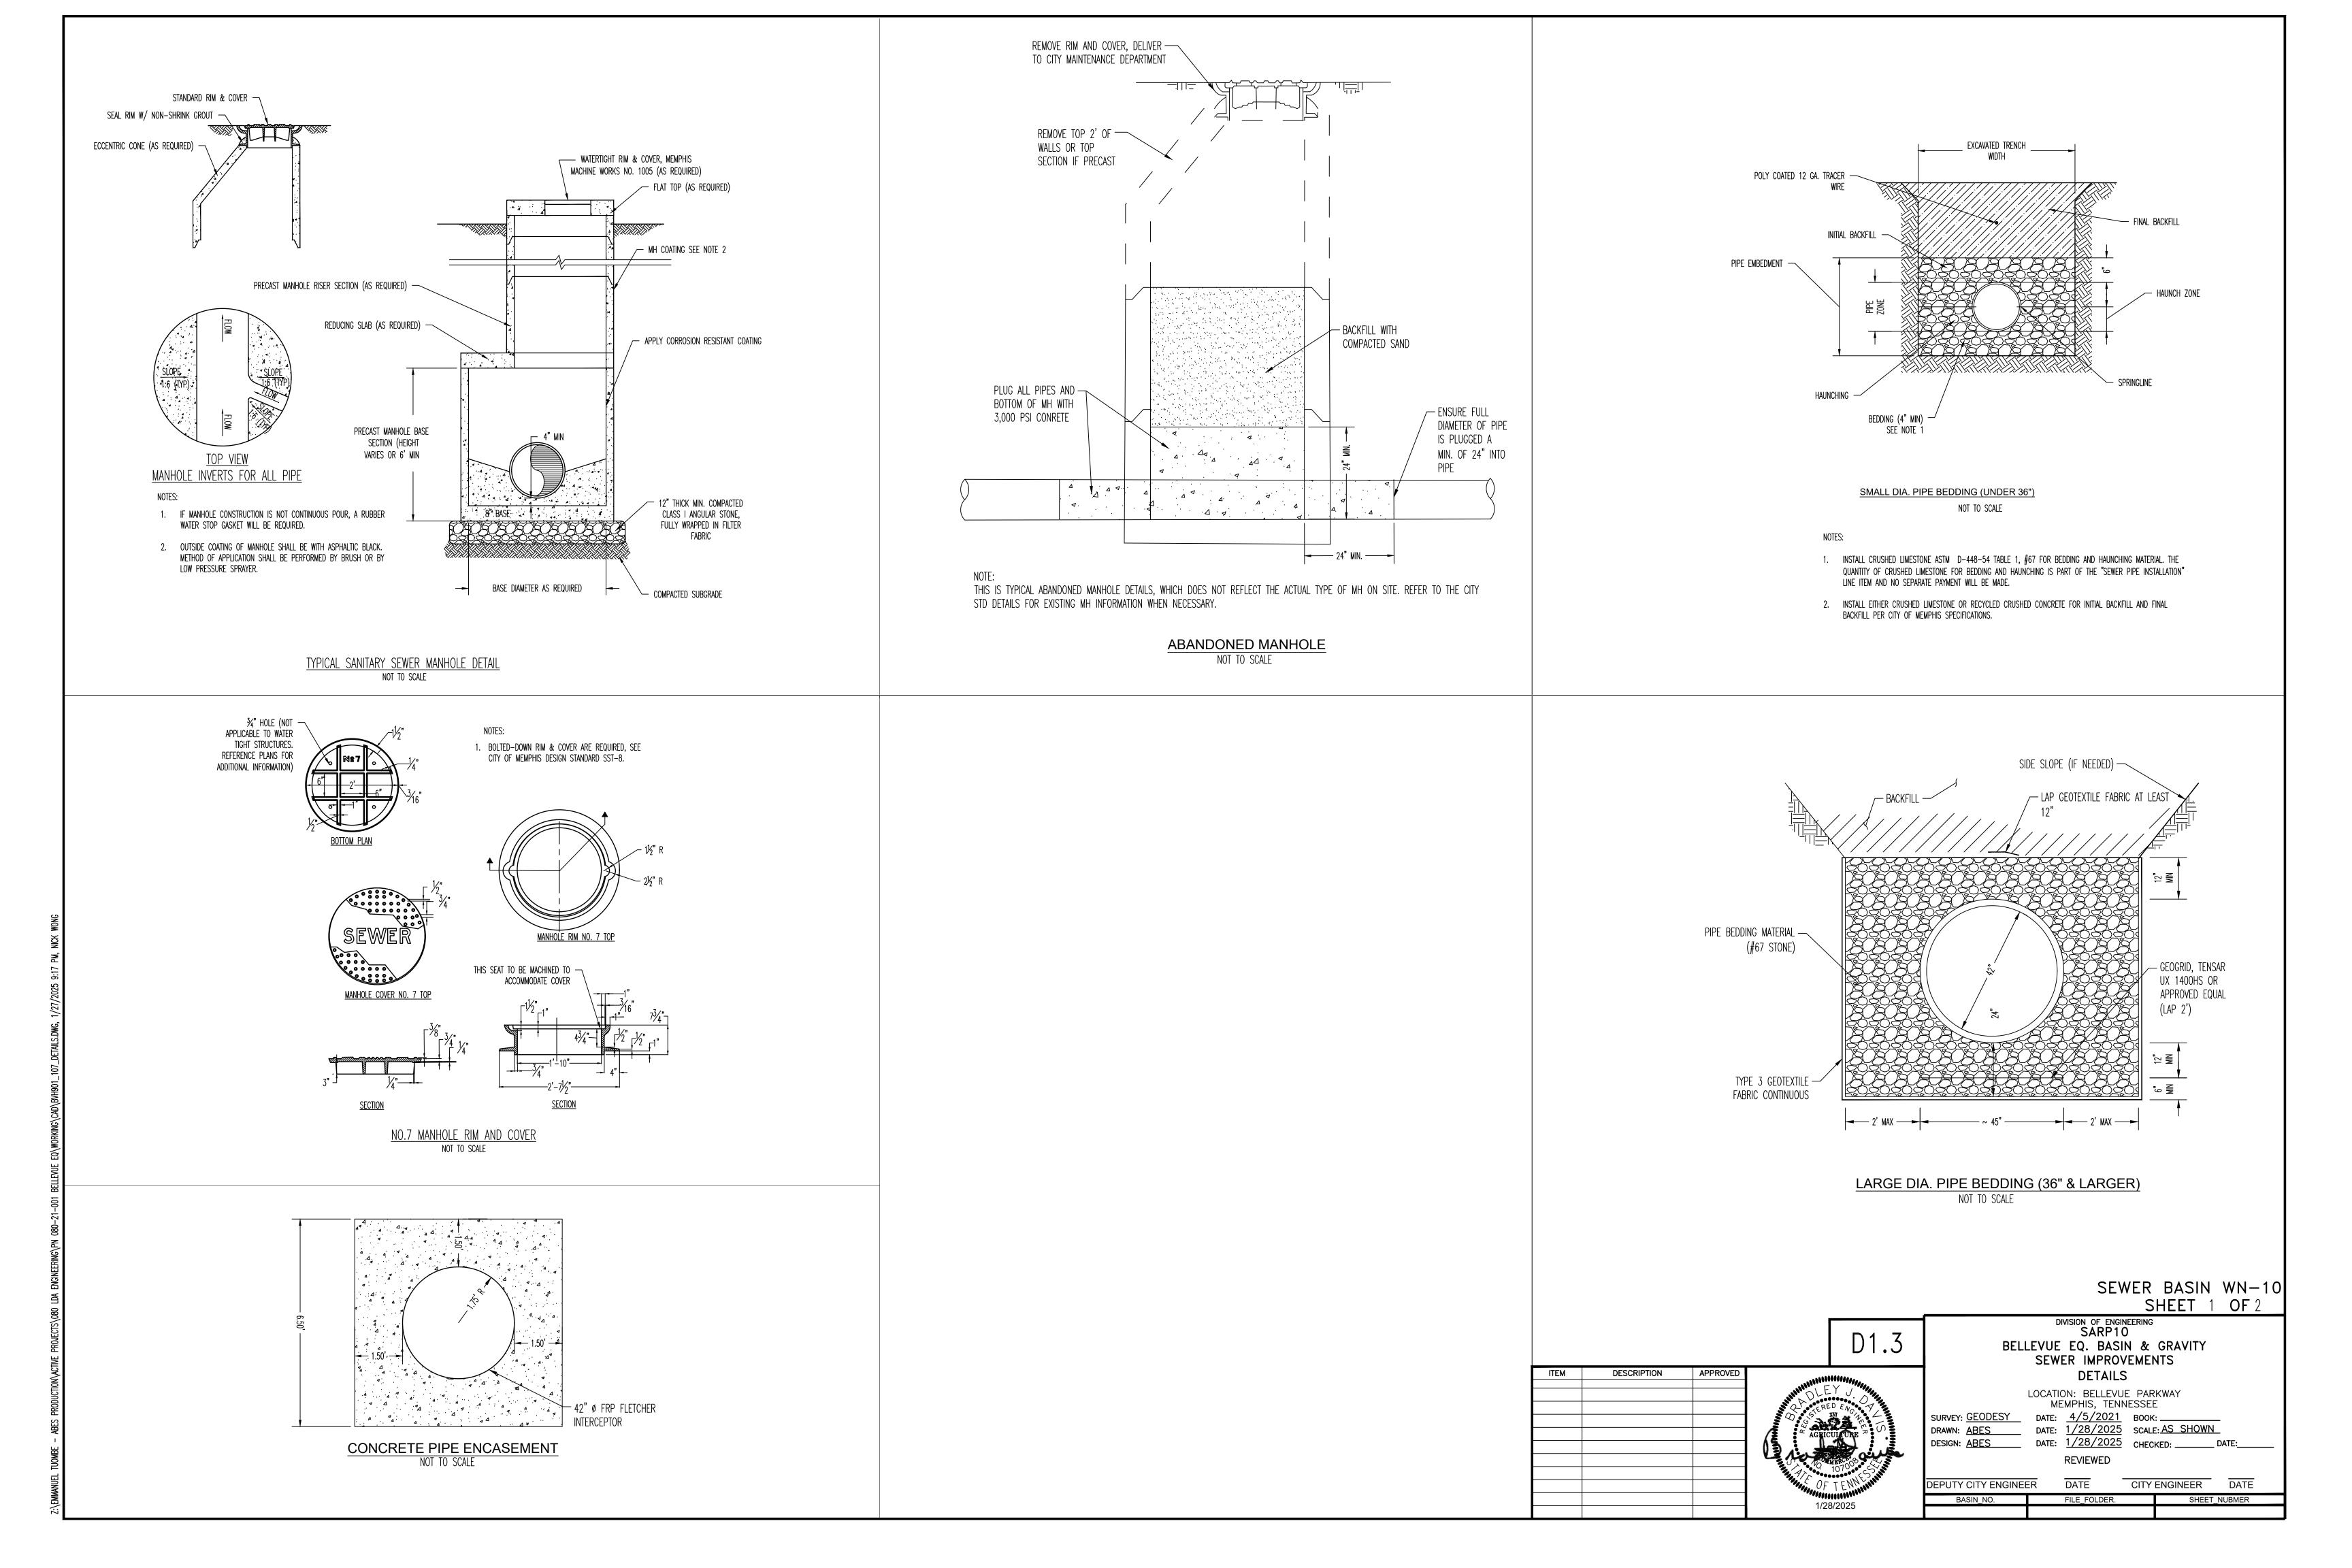


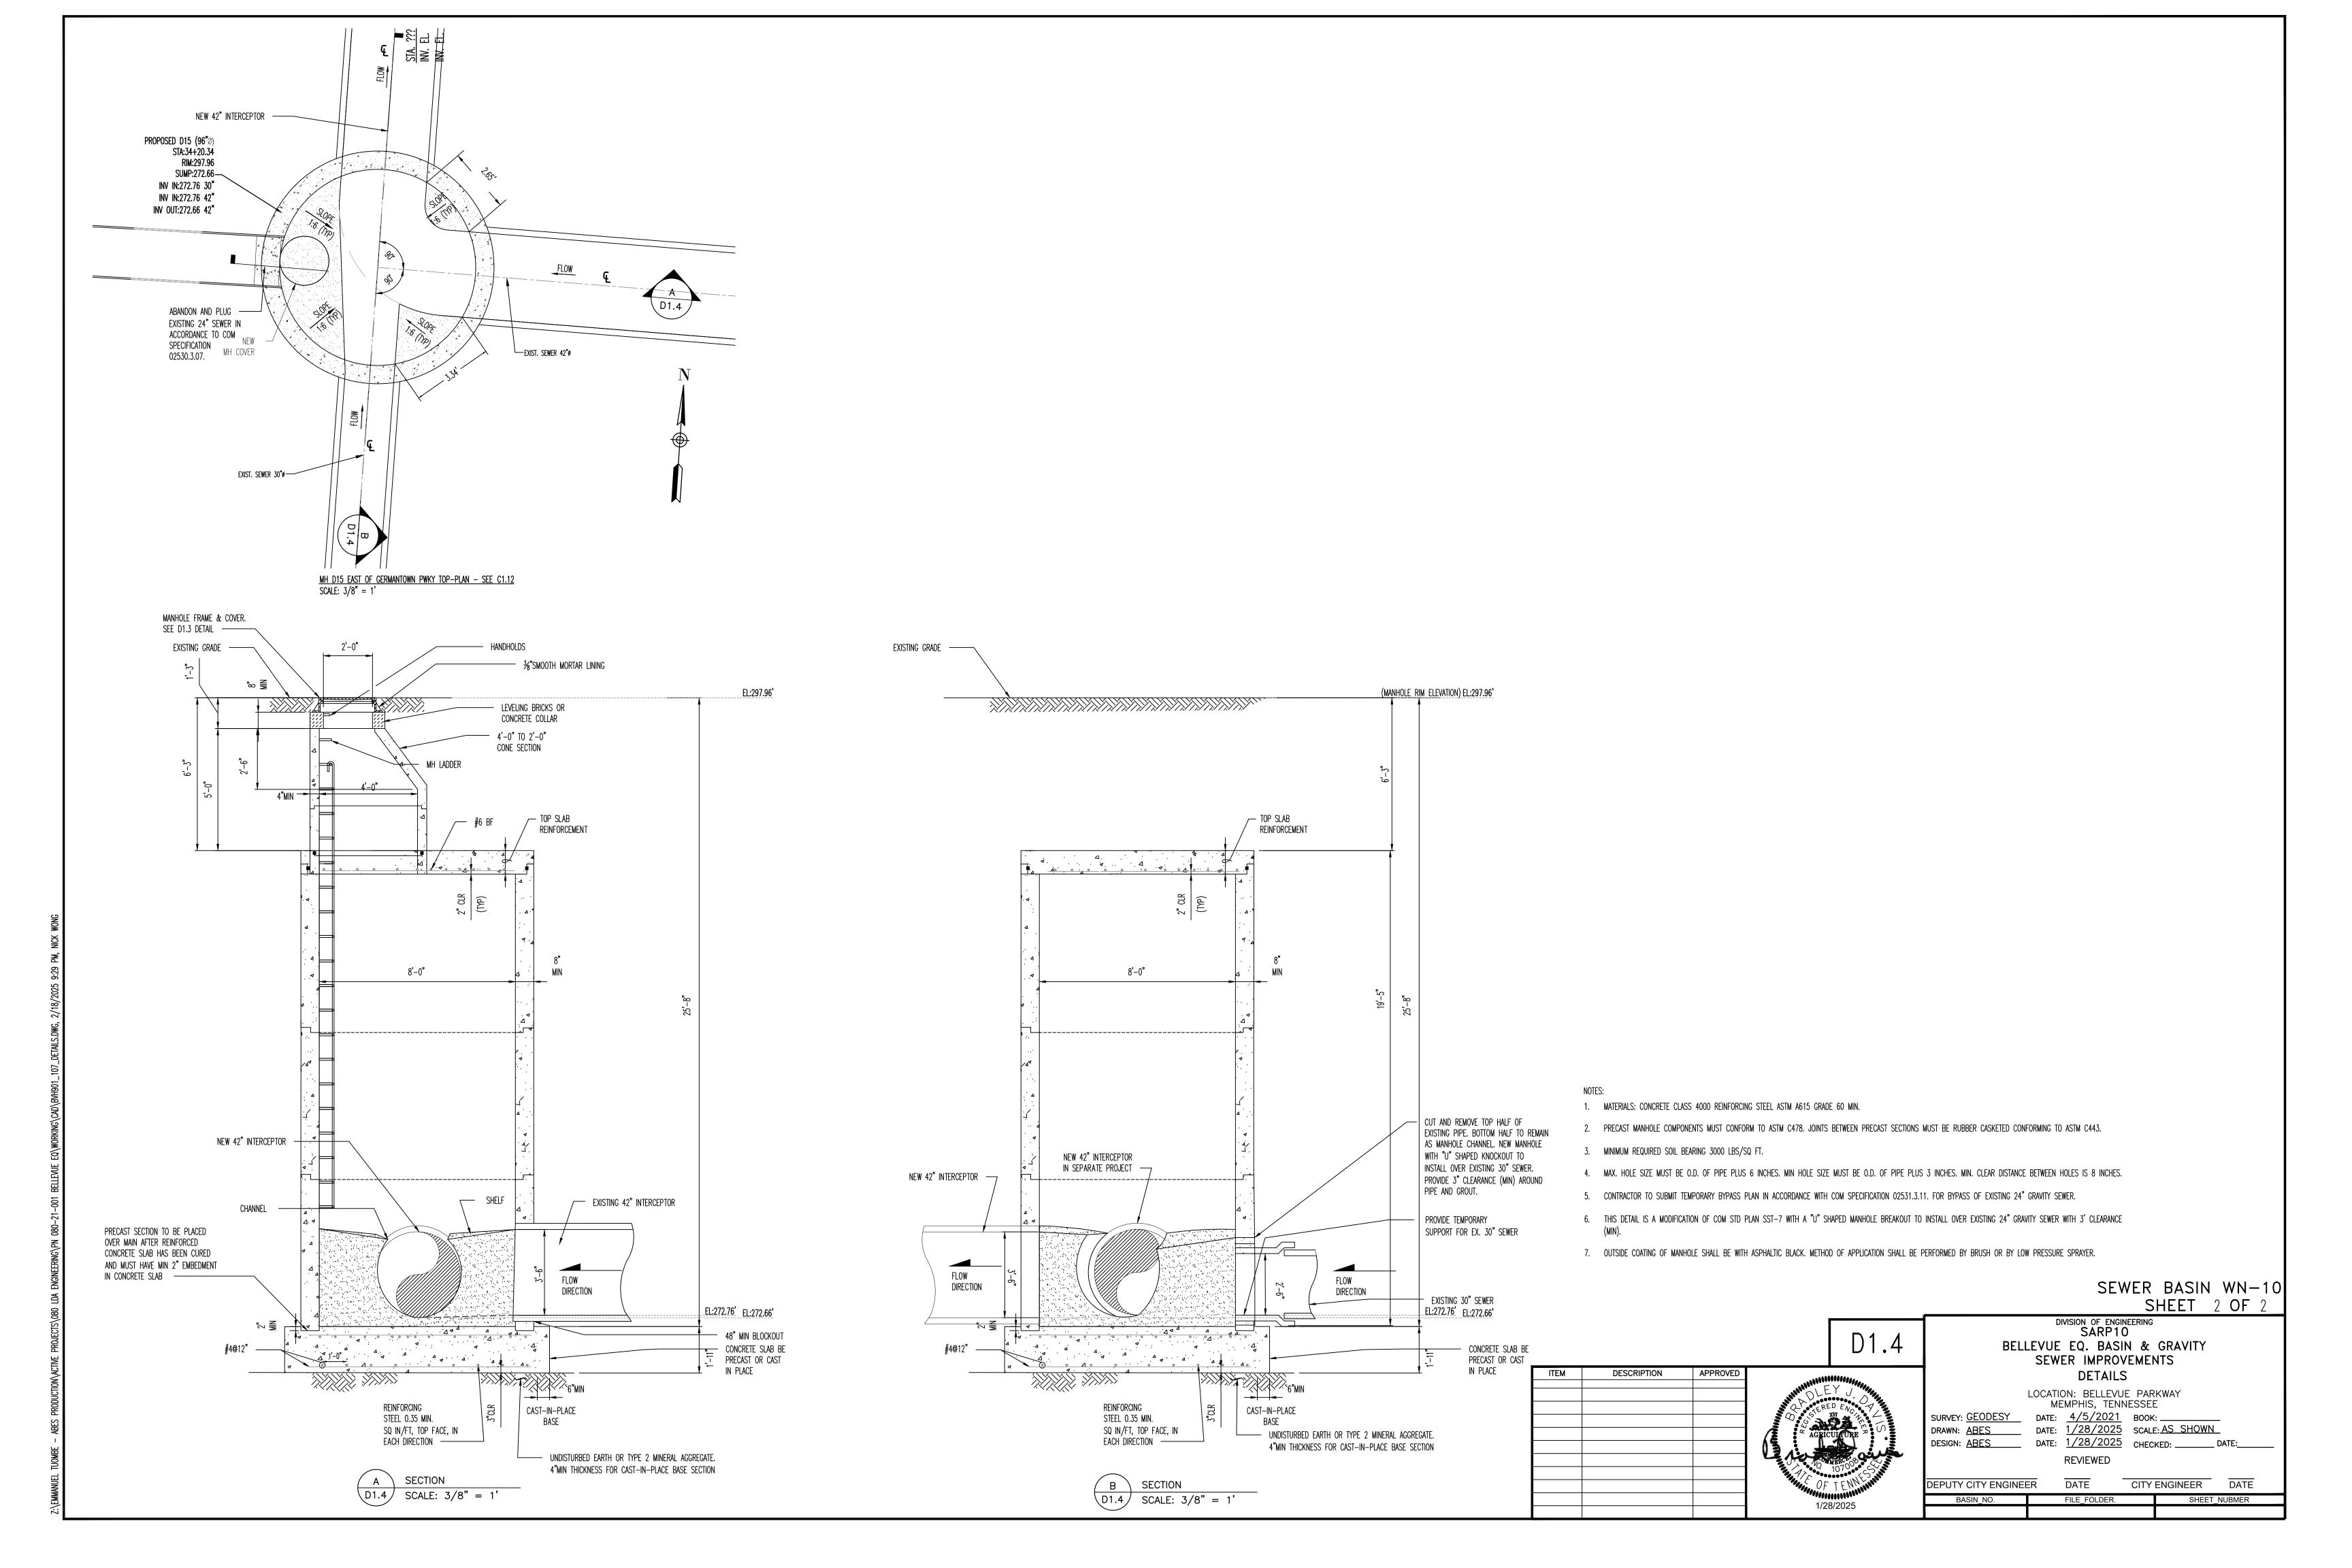

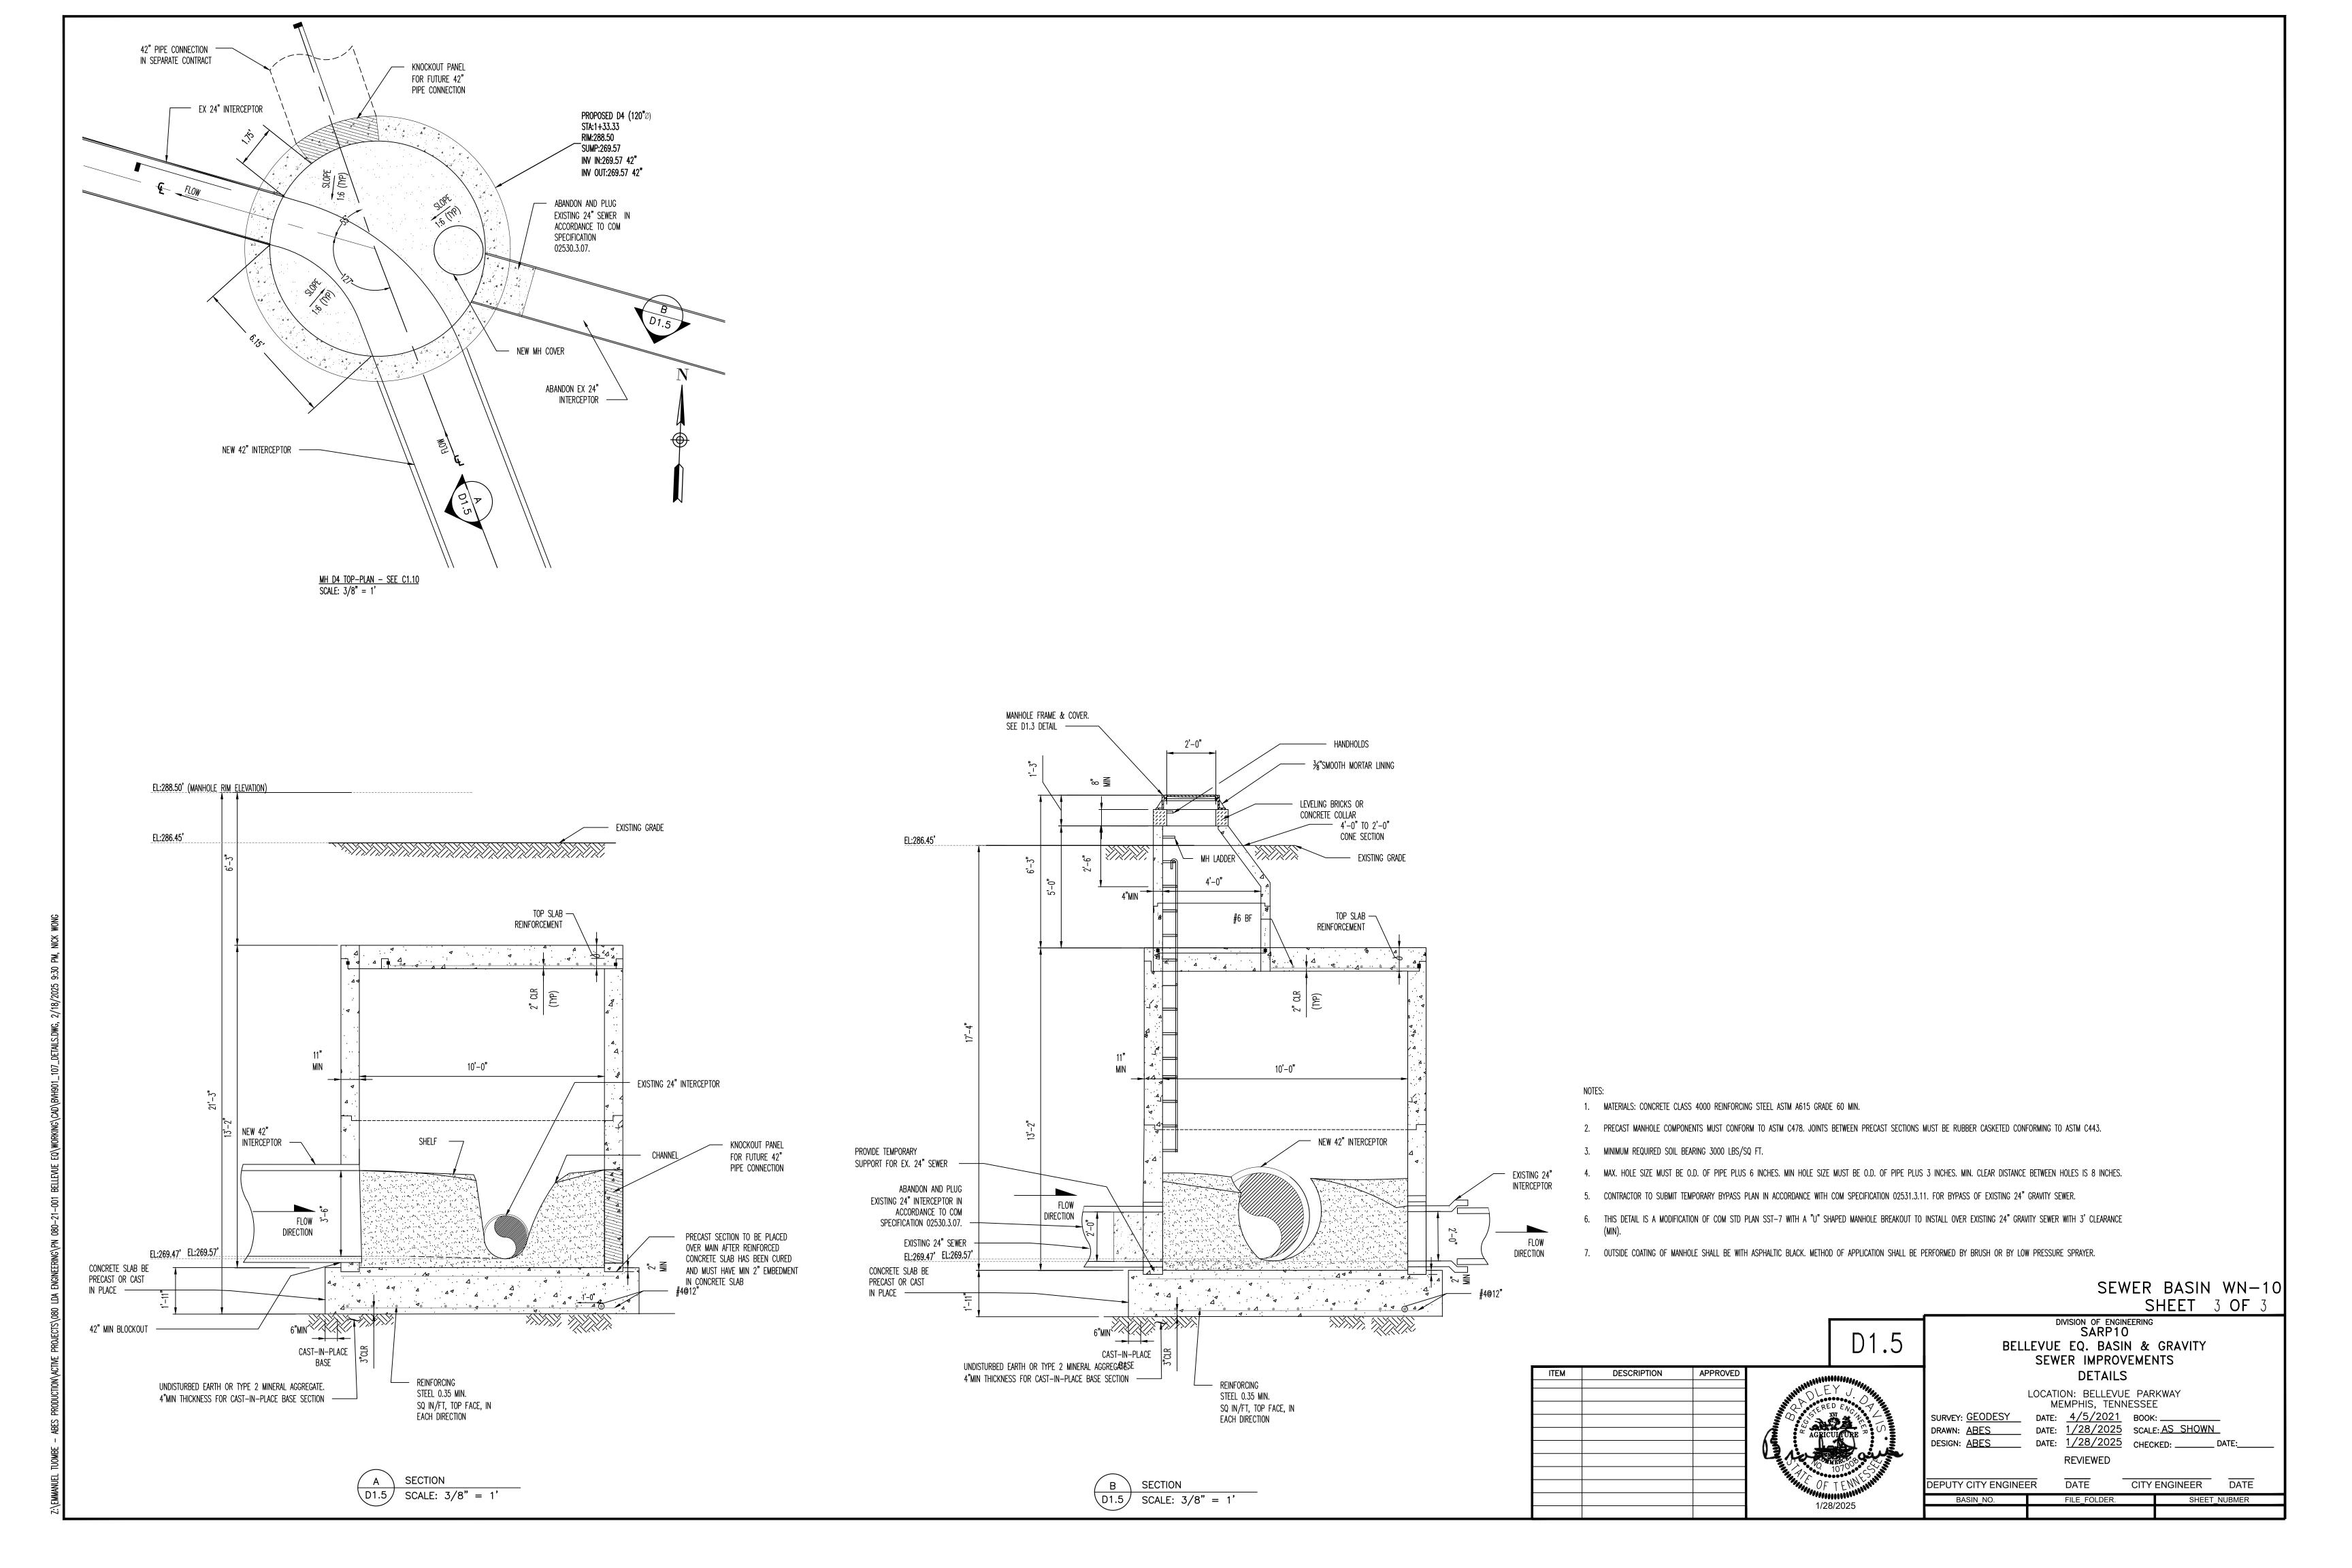


D1.6

NOT TO SCALE

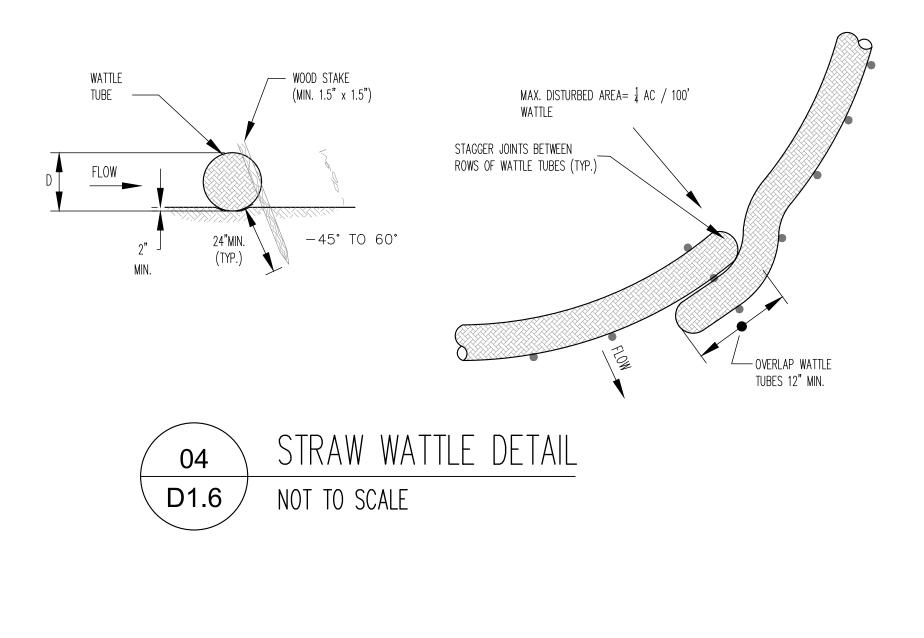

DESCRIPTION

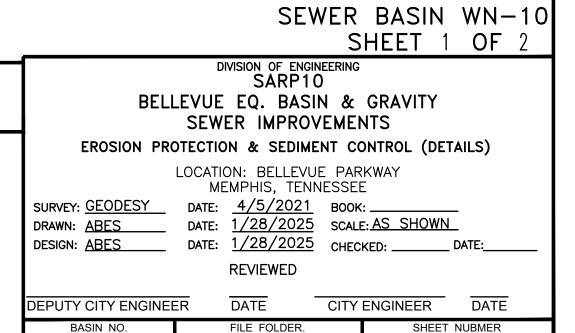

/ MIN. 2.25" (NOMINAL) X 2.25"

POSITION POST/FABRIC

ASSEMBLY AT VERTICAL

THE VERTICAL (ANGLED

FLOW

EXISTING -GROUND

ANCHOR SILT FENCE -FABRIC 6" DEEP WITH

4" RUN-OUT LENGTH

EXISTING GROUND

SECTIONAL VIEW

SILT FENCE FABRIC

MIN. 5 FASTNERS_

BACKFILL WITH

COMPACTED SOIL

TO A MAX. 5° FROM

TOWARD FLOW)


(NOMINAL) - (1.75" ACTUAL X 1.75"

ACTUAL) (3.06 SQ. IN.) HARDWOOD

POST (OAK OR HICKORY) OR MIN.

1.25 LB./FT. STEEL POST (STD. "T"

OR "U" SECTION) — LENGTH 58"

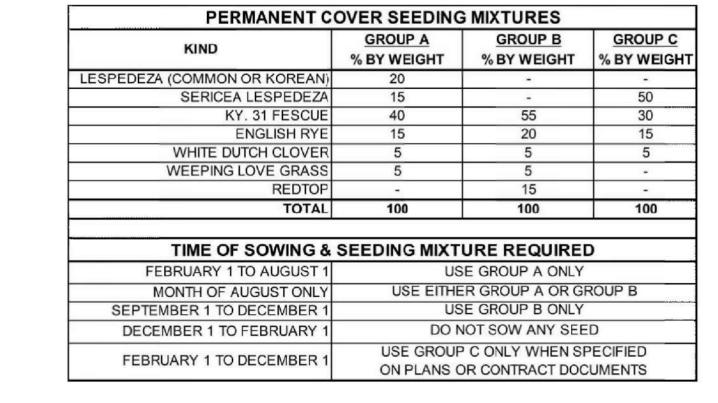

COVER SEEDING MIXTURE NOT TO SCALE

VERTICAL POST

6' - 0" MAX.


ELEVATION

ELEVATION FENCE ON SLOPE

SENSITIVE AREA AREA **ISOMETRIC**

GENERAL NOTES

- HIGH VISIBILITY FENCE IS INTENDED TO BE PLACED TO PREVENT DISTURBANCE OF SENSITIVE AREAS, THEIR BUFFERS, AND OTHER AREAS REQUIRED TO BE LEFT UNDISTURBED DURING CONSTRUCTION. IT MAY ALSO BE USED TO MARK APPROVED CLEARING LIMITS AND TO CONTROL VEHICLE ACCESS TO AND ON THE PROJECT SITE.
- HIGH VISIBILITY FENCE FABRIC SHALL BE MACHINED PRODUCED ORANGE COLORED MESH MANUFACTURED FROM POLYPROPYLENE OR POLYETHYLENE. IT SHALL BE FULLY STABILIZED ULTRAVIOLET RESISTANT.
- HIGH VISIBILITY FENCE FABRIC MAY BE MADE FROM RECYCLED MATERIALS. MATERIALS SHALL NOT CONTAIN BIODEGRADABLE FILLER MATERIALS THAT CAN DEGRADE THE PHYSICAL OR CHEMICAL CHARACTERISTICS OF THE FINISHED FABRIC.
- HIGH VISIBILITY FENCE FABRIC SHALL HAVE A MINIMUM 4 FOOT WIDTH AND SHALL BE FURNISHED IN ONE CONTINUOUS WIDTH AND SHALL NOT BE SPLICED TO CONFORM TO THE SPECIFIED WIDTH DIMENSION.
- STEEL POST SHALL BE ROLLED FROM HIGH CARBON STEEL AND SHALL HAVE A MINIMUM WEIGHT OF 1.25 LB/FT. POST SHALL BE HOT-DIPPED GALVANIZED OR PAINT. STEEL POST MAY BE EQUIPPED WITH AN ANCHOR PLATE HAVING A MINIMUM AREA OF 14 SQUARE INCHES. IF POSTS ANCHOR PLATES USED THEY SHALL CONFORM TO THE REQUIREMENTS
- HIGH VISIBILITY FENCE FABRIC SHALL BE FASTENED TO THE POST USING TIE WIRE OR SELF-LOCKING PLASTIC FASTENERS WITH A MAXIMUM FASTENERS SPACING OF 2 FEET. WHEN WOOD POSTS ARE USED THE FASTENERS SHALL BE STAPLED TO THE POST.
- HIGH VISIBILITY FENCE THAT IS DAMAGED DURING CONSTRUCTION SHALL BE REPAIRED OR REPLACED AT THE CONSTRUCTORS EXPENSE ON THE SAME DAY THE DAMAGE
- (H) HIGH VISIBILITY FENCE SHALL BE PAID FOR UNDER THE FOLLOWING ITEM NUMBER: 707-08.11 HIGH VISIBILITY CONSTRUCTION FENCE, L.F.
 - PAYMENT SHALL INCLUDE ALL MATERIALS AND LABOR NECESSARY FOR CONSTRUCTION MAINTENANCE, AND REMOVAL OF HIGH VISIBILITY FENCE.
- OSHA 1926.701(B) COMPLIANT (IMPALEMENT PREVENTING) POST CAPS SHALL BE REQUIRED FOR ANY METAL POST ABOVE WHICH PEOPLE MAY BE WORKING AND THE RISK OF FALLING DOWN ONTO THE POST IS PRESENT; REGARDLESS OF HOW HIGH THE POST STICKS UP OUT OF THE GROUND. PLASTIC "MUSHROOM-STYLE" POST CAPS SHALL BE REQUIRED FOR ANY METAL POST WITH AN INSTALLED HEIGHT LESS THAN 36" ABOVE THE GROUND AND WHEN THERE ARE NO WORKERS CONDUCTING WORK ABOVE THE POSTS. NO CAPS SHALL BE REQUIRED FOR METAL POSTS WITH AN INSTALLED HEIGHT OF 36" OR GREATER AND WHEN THERE ARE NO WORKERS CONDUCTING WORK ABOVE THE POSTS. ALL CAPS SHALL BE ORANGE OR YELLOW TO ENHANCE VISIBILITY. WHEN REQUIRED, PAYMENT OF POST CAPS SHALL BE INCLUDED IN THE TOTAL COST OF HIGH VISIBILITY FENCE.

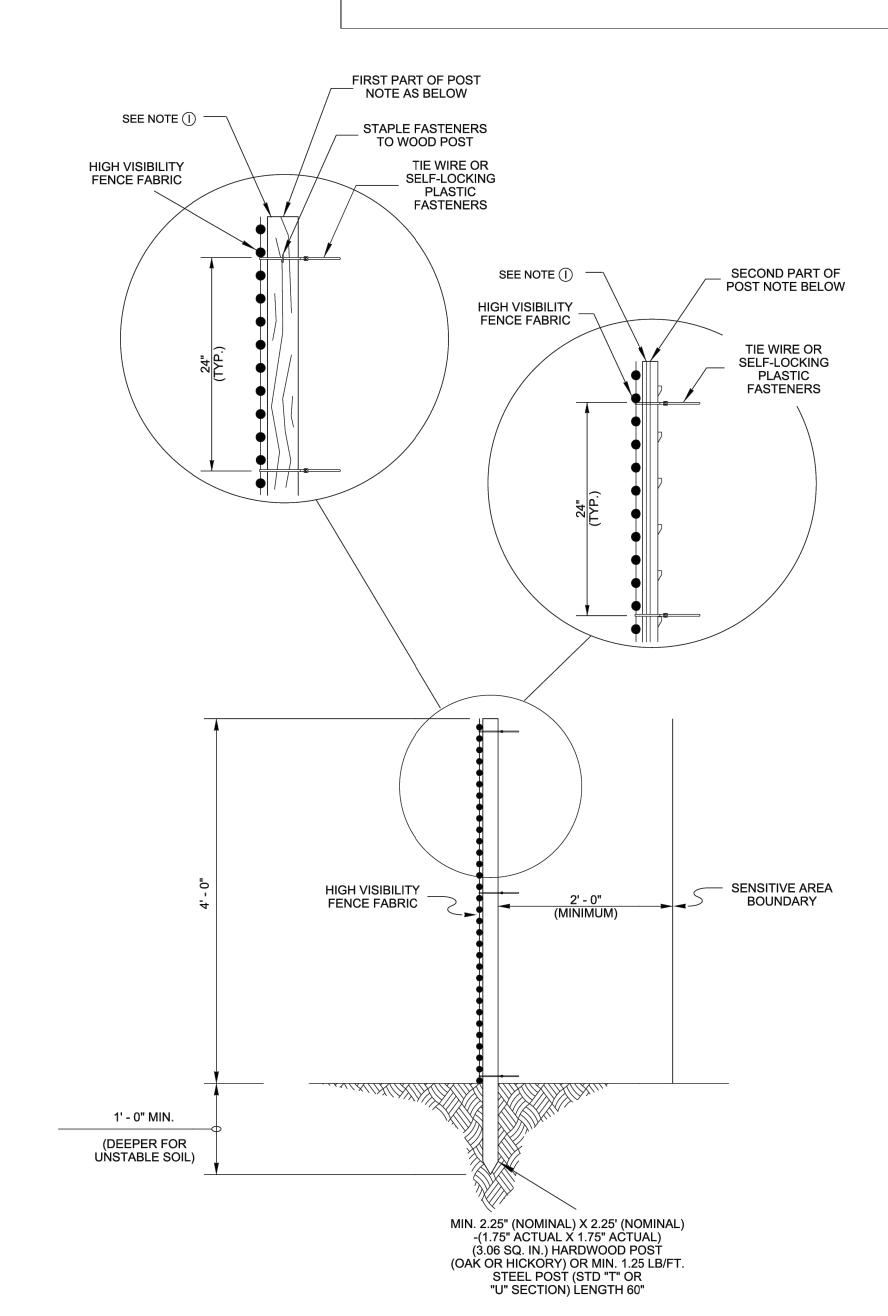

DESCRIPTION APPROVED

SEWER BASIN WN-10 SHEET 2 OF 2 DIVISION OF ENGINEERING SARP10

BELLEVUE EQ. BASIN & GRAVITY SEWER IMPROVEMENTS EROSION PROTECTION & SEDIMENT CONTROL (DETAILS)

LOCATION: BELLEVUE PARKWAY MEMPHIS, TENNESSEE

SURVEY: GEODESY DATE: 4/5/2021 BOOK: _____ DRAWN: ABES DATE: 1/28/2025 SCALE: AS SHOWN DESIGN: <u>ABES</u> DATE: 1/28/2025 CHECKED: _____ DATE: _____

REVIEWED CITY ENGINEER DATE DATE DEPUTY CITY ENGINEER FILE FOLDER. SHEET_NUBMER BASIN NO.


D1.7

CONSTRUCTION FENCE DETAIL NOT TO SCALE

METAL POST CAPS

EXAMPLE OF PLASTIC "MASHROOM-STYLE" POST CAP

EXAMPLE OF OSHA 1926.701 (b) COMPLIANT (IMPALEMENT PREVENTING) POST CAP

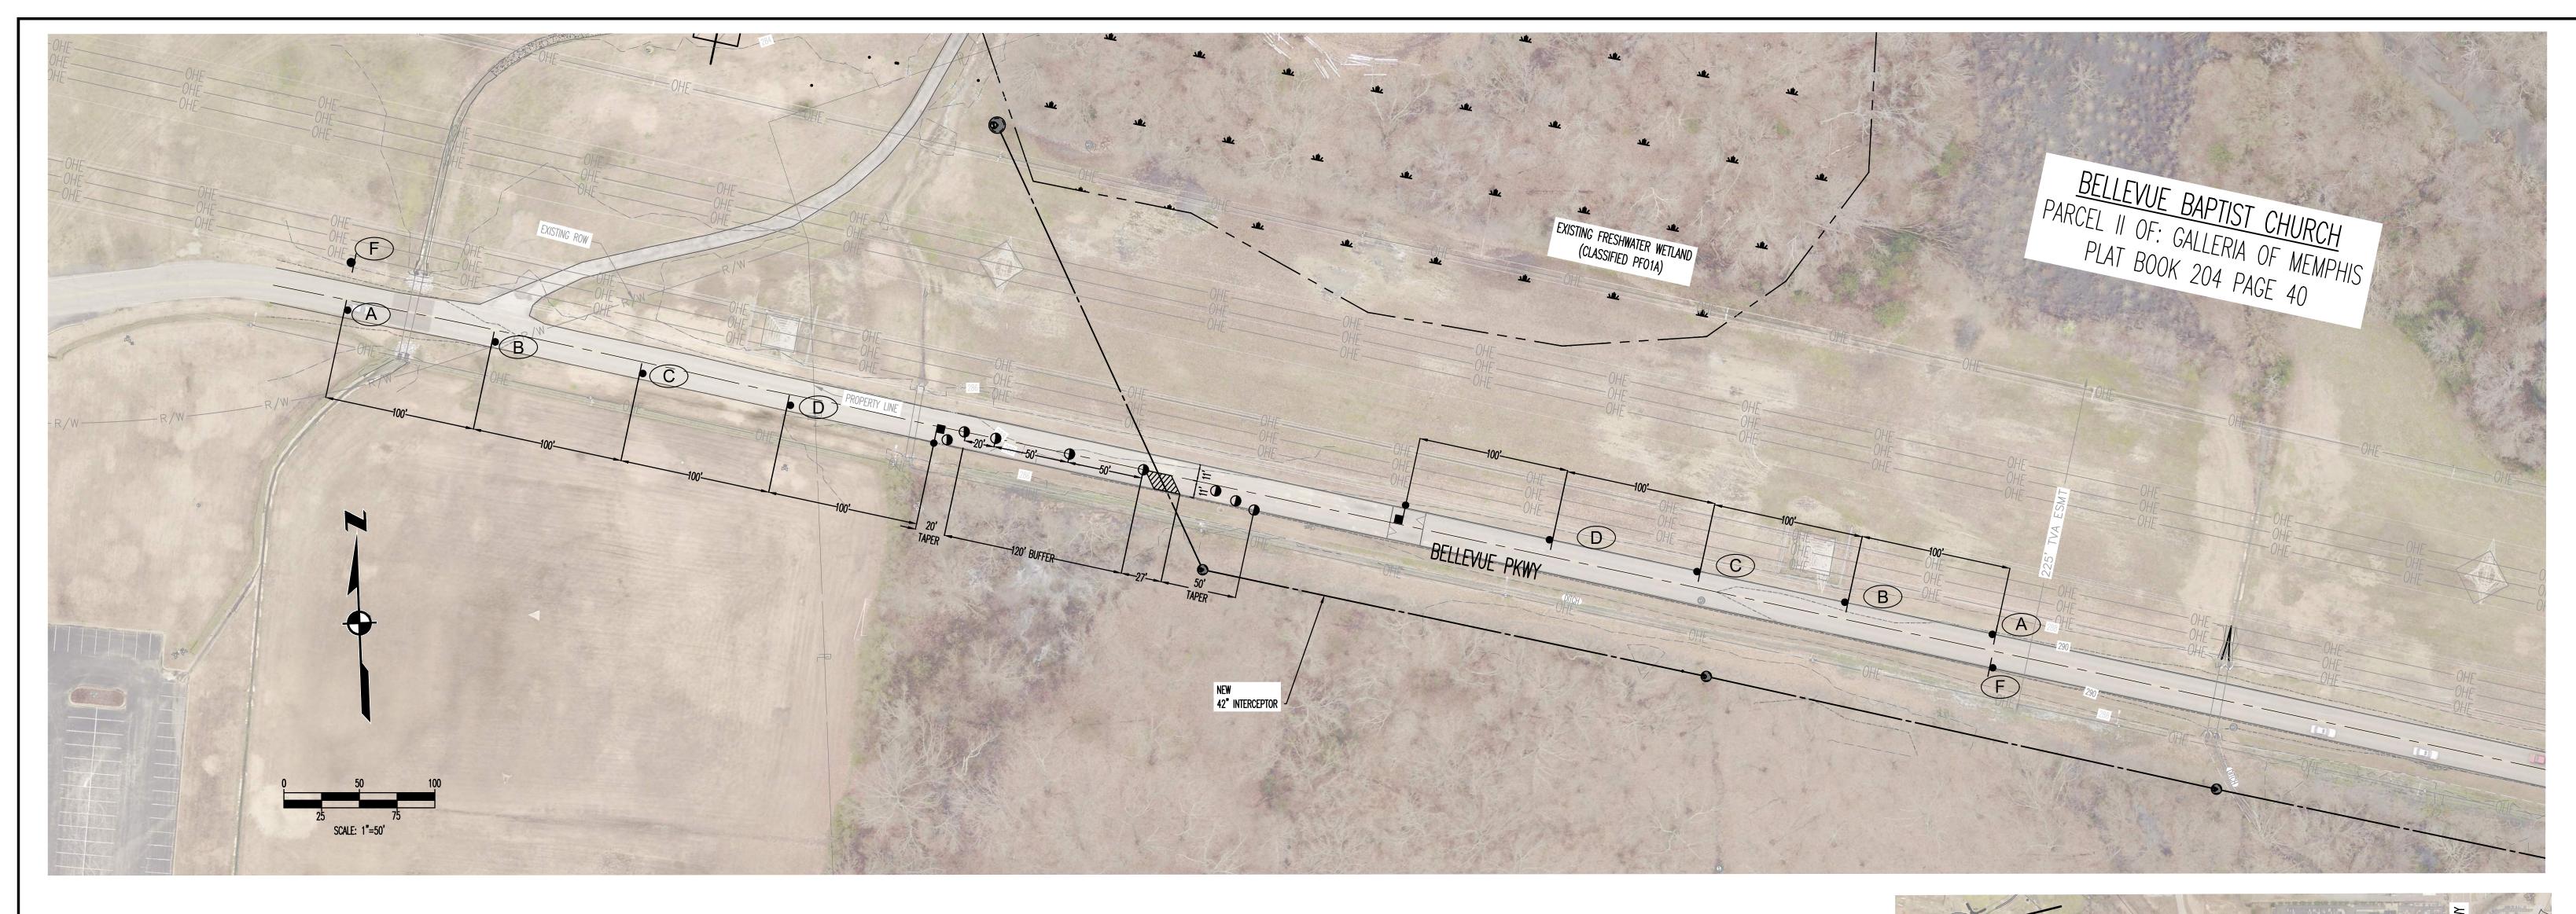

BELLEVUE PKWY TCP (PHASE 1)

SCALE: 1'' = 50'

TRAFFIC CONTROL PLAN NOTES


- SEE SECTION 6F.02, SIGN PLACEMENT, OF THE MANUAL ON UNIFORM TRAFFIC CONTROL DEVICES (MUTCD) FOR INFORMATION ON PLACEMENT AND MOUNTING OF SIGNS.
- SIGNS SHOWN ON THIS PLAN ARE TO WARN TRAFFIC ABOUT THE CONSTRUCTION. OTHER TRAFFIC CONTROL DEVICES MAY BE REQUIRED DURING VARIOUS PHASES OF CONSTRUCTION. NOTHING IN THIS PLAN IS INTENDED TO SUPERSEDE OR RELIEVE THE CONTRACTOR OF THE RESPONSIBILITY OF INSTALLING THE APPROPRIATE TRAFFIC CONTROL DEVICES IN ACCORDANCE WITH THE CURRENT MANUAL ON UNIFORM TRAFFIC CONTROL DEVICES FOR STREETS AND HIGHWAYS.
- CONTRACTOR SHALL BE REQUIRED TO NOTIFY THE CITY OF MEMPHIS CONSTRUCTION INSPECTION DEPARTMENT (901) 636-2462 AND TRAFFIC ENGINEERING DEPARTMENT 901) 636-6710 A MINIMUM OF 24 HOURS PRIOR TO COMMENCING CONSTRUCTION OR IMPLEMENTING A TRAFFIC CONTROL PLAN. ALL TRAFFIC CONTROL DEVICES MUST BE IN PLACE BEFORE CONSTRUCTION ACTIVITY BEGINS. SIZES OF ALL SIGNS SHALL COMPLY WITH THE MANUAL ON UNIFORM TRAFFIC CONTROL DEVICES (MUTCD).
- ALL TRAFFIC CONTROL DEVICES AND THEIR INSTALLATION SHALL MEET THE STANDARD PRESCRIBED IN THE MANUAL ON UNIFORM TRAFFIC CONTROL DEVICES AND SHALL COMPLY WITH THE STATE OF TENNESSEE STANDARD SPECIFICATIONS FOR ROAD AND BRIDGE CONSTRUCTION SECTION 712 TEMPORARY TRAFFIC CONTROL.
- ACCESS TO ADJACENT PROPERTIES SHALL BE MAINTAINED AT ALL TIMES. SIDE STREET, DRIVEWAY ACCESS, AND SAFE PEDESTRIAN WAYS SHALL BE MAINTAINED AT ALL TIMES.
- THE CONTRACTOR SHALL NOT BE PERMITTED TO PARK ANY VEHICLES OR CONSTRUCTION EQUIPMENT DURING PERIODS OF INACTIVITY, WITHIN THE RIGHT-OF-WAY OR WITHIN THIRTY (30) FEET OF THE EDGE OF PAVEMENT WHICHEVER IS LESS, WHEN THE LANE IS OPEN TO TRAFFIC, UNLESS PROTECTED BY GUARDRAIL, BRIDGE RAIL, AND/OR BARRIERS INSTALLED FOR OTHER PURPOSES. PRIVATELY OWNED VEHICLES SHALL NOT BE ALLOWED TO BE PARKED WITHIN THE RIGHT-OF-WAY OR WITHIN THIRTY (30) FEET OF AN OPEN TRAFFIC LANE WHICHEVER IS LESS, AT ANY TIME UNLESS PROTECTED AS DESCRIBED ABOVE.
- CONTRACTOR SHALL USE PLASTIC DRUMS WITH TYPE "A" WARNING LIGHTS TO SEPARATE TRAFFIC FROM THE CONSTRUCTION AREA. DRUMS WITH TYPE "A" WARNING LIGHTS SHALL DELINEATE THE EDGE OF PAVEMENT THROUGH THE ENTIRE CONSTRUCTION AREA.
- CONTRACTOR SHALL COVER ALL EXISTING SIGNS THAT CONFLICT WITH THE TRAFFIC CONTROL PLAN SIGNS OR DEVICES DURING CONSTRUCTION AND THEY SHALL REMAIN COVERED DURING CONSTRUCTION AND UNTIL SUCH TIME THAT NO CONFLICT EXISTS.
- CONTRACTOR SHALL INSTALL TEMPORARY NO PARKING SIGNS AS REQUIRED WITHIN THE TRAFFIC CONTROL AREA.
- WORK WITHIN THE ROADWAY DURING DIFFERENT PHASES OF CONSTRUCTION SHALL NOT BE ACTIVE AT THE SAME TIME.
- ONLY ONE PHASE OF THE TRAFFIC CONTROL PLAN SHALL BE ACTIVE AT ANY ONE TIME.


DETERMINE FEES ASSOCIATED WITH ANY ENGINEERING PERMITS REQUIRED (I.E. DUMPSTER PERMITS, PARKING METER PERMITS, ETC.).

- ALL TEMPORARY OR PERMANENT TRAVELED SURFACE SHALL BE INSPECTED DAILY BY THE CONTRACTOR (INCLUDING WEEKENDS) AND NECESSARY PATCHING OR RE-FINISHING PERFORMED. THE CONTRACTOR SHALL CONTACT THE CITY OF MEMPHIS TRAFFIC ENGINEERING DEPARTMENT AT 901-636-6710 AT LEAST ONE WEEK PRIOR TO IMPLEMENTING THE TRAFFIC CONTROL PLAN TO
- CHANNELIZING DEVICES SHALL BE REMOVED TO THE EDGE OF PAVEMENT AT THE END OF EACH WORK DAY. NO CLOSURE SHALL BE IN EFFECT FROM 4:00 P.M. UNTIL 9:00 A.M. TWO 12 FOOT LANES SHALL BE OPEN DURING THIS PERIOD WITH AT LEAST A 4 INCH THICK COMPACTED GRAVEL SURFACE.
- WORK WITHIN THE ROADWAY SHALL BE CONDUCTED BETWEEN 9:00 A.M. AND 4:00 P.M. AND THE ROADWAY SHALL BE COMPLETELY OPEN TO TRAFFIC AT ALL OTHER TIMES AND ALL INAPPROPRIATE SIGNS SHALL BE COVERED OR REMOVED. AT NO TIME SHALL ONE LANE SECTION BE LEFT OPEN UNATTENDED. WHERE TWO FLAGGERS ARE REQUIRED AND IN CIRCUMSTANCES WHERE ONLY ONE LANE OF TRAFFIC IS OPEN AND THERE IS NO CLEAR LINE OF SIGHT FROM ONE END OF THE CONSTRUCTION AREA TO THE OTHER, THE CONTRACTOR SHALL PROVIDE RADIO COMMUNICATION OR OTHER APPROPRIATE MEANS OF ESTABLISHING
- CONTROL OF TRAFFIC. CONTRACTOR SHALL CONTACT THE CITY OF MEMPHIS SIGNAL SHOP AT 528-2844 FOR LOCATION OF SIGNAL CONDUIT AND WIRES.
- THE APPROPRIATE TRAFFIC CONTROL SHALL BE INSTALLED AT THE INCEPTION OF EACH STAGE OF CONSTRUCTION AND SHALL BE PROPERLY MAINTAINED AND/OR OPERATED DURING THE TIME SUCH SPECIAL CONDITIONS EXIST. THEY SHALL REMAIN IN PLACE ONLY AS LONG AS THEY ARE NEEDED AND SHALL BE IMMEDIATELY REMOVED THEREAFTER.
- OBLITERATED MARKINGS SHALL BE UNIDENTIFIABLE AS PAVEMENT MARKINGS UNDER DAY OR NIGHT, WET OR DRY CONDITIONS. OVERLAYING EXISTING STRIPES WITH BLACK PAINT OR ASPHALT DOES NOT MEET THE REQUIREMENTS OF COVERING, REMOVAL, OR OBLITERATION; HOWEVER, THE USE OF REMOVABLE, NON-REFLECTIVE, PREFORMED TAPE IS PERMITTED WHERE MARKINGS NEED TO BE COVERED TEMPORARILY.
- EXISTING STRIPING THAT CONFLICTS WITH THE TEMPORARY TRAFFIC CONTROL DEVICES SHALL BE COVERED OR REMOVED DURING CONSTRUCTION. WHEN CONSTRUCTION IS COMPLETE THE EXISTING STRIPING SHALL BE RETURNED TO ITS ORIGINAL STATE.
- ALL TRAFFIC CONTROL SIGNS SHALL MEET THE MINIMUM RETRO REFLECTIVITY LEVELS SPECIFIED IN THE CURRENT EDITION OF THE MANUAL ON UNIFORM TRAFFIC CONTROL DEVICES (MUTCD). THE DEVELOPER SHALL PROVIDE A TRAFFIC CONTROL PLAN TO THE CITY ENGINEER THAT SHOWS THE PHASING FOR EACH STREET FRONTAGE DURING DEMOLITION OR CONSTRUCTION OF CURB, GUTTER AND SIDEWALK. IF A TEMPORARY SIDEWALK IS PROVIDED, IT SHALL BE ADA ACCESSIBLE AND A MINIMUM 5 FEET WIDE PEDESTRIAN PATHWAY.
- ANY CLOSURE OF THE RIGHT OF WAY SHALL BE TIME LIMITED TO THE ACTIVE DEMOLITION OR CONSTRUCTION. CONTINUOUS UNWARRANTED CLOSURE OF THE RIGHT OF WAY SHALL NOT BE ALLOWED. FOR THE DURATION OF THE PROJECT. TIME LIMITS WILL BEGIN ON THE DAY OF CLOSURE AND WILL BE MONITORED BY THE ENGINEERING CONSTRUCTION INSPECTORS (901) 636-2462 ON THE JOB. ANYTIME FLAGGER IS NOT PRESENT TO CONTROL TRAFFIC, TWO TRAFFIC LANES MUST BE OPEN TO MAINTAIN TWO-WAY TRAFFIC AND ALL INAPPROPRIATE SIGNS SHALL BE COVERED OR REMOVED.
- 29. ALL FLAGGERS SHALL BE EQUIPPED WITH A **STOP/SLOW** PADDLE. 30. THE CONTRACTOR SHALL NOTIFY MEMPHIS AREA TRANSIT AUTHORITY (MATA) AT 901-722-7100 A MINIMUM OF 48 HOURS PRIOR TO IMPLEMENTING A TRAFFIC CONTROL PLAN.

TRAFFIC CONTROL LEGEND		
SYMBOL	ITEM	
7777	WORK ZONE	
•	FLEXIBLE DRUMS (CHANNELIZING)	
Þ	SIGN (CONSTRUCTION)	
•=	FLAGGER	

10 MPH	
1 MONTH	

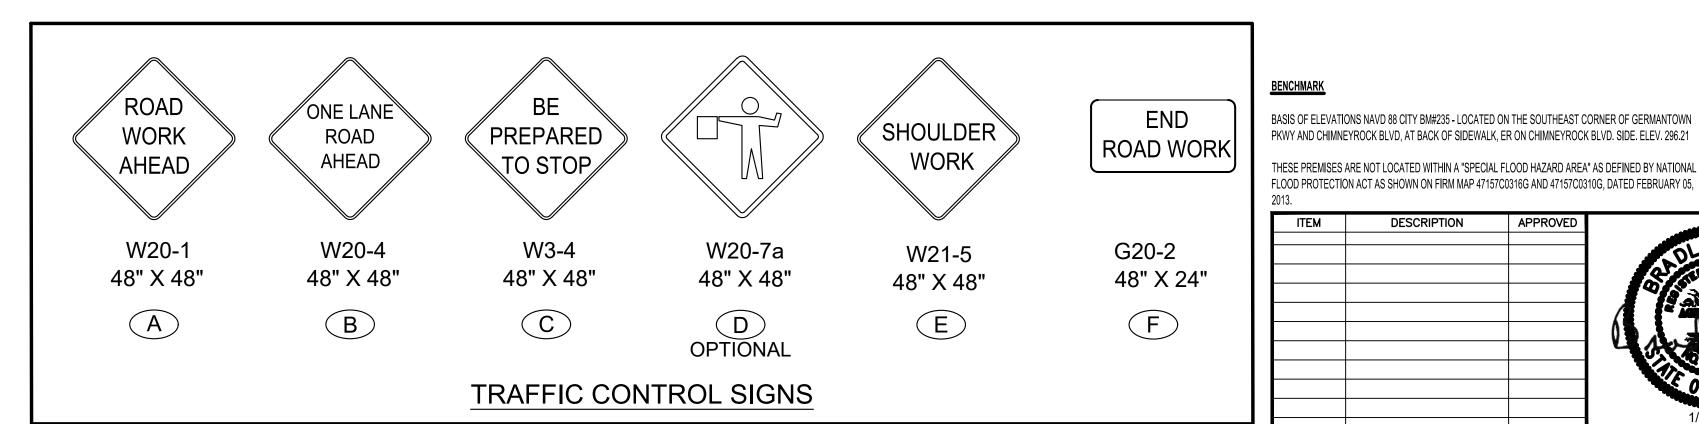

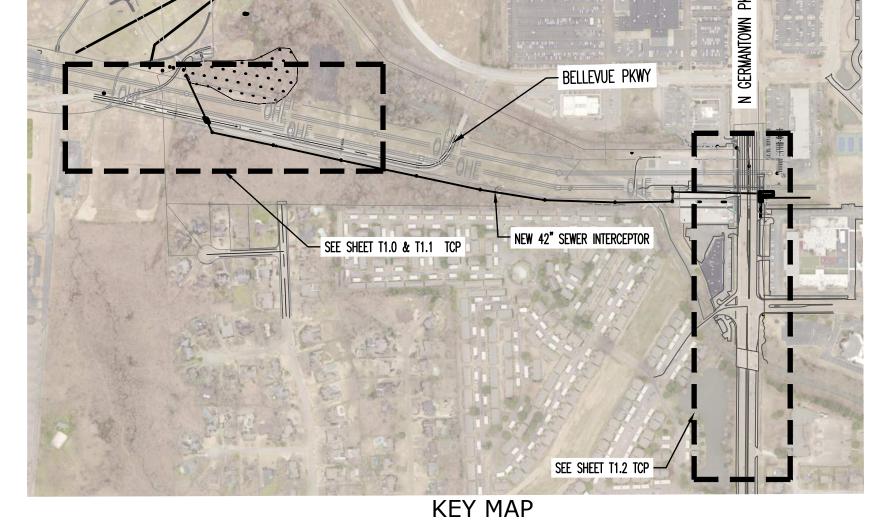



DIVISION OF ENGINEERING **SARP10** BELLEVUE EQ. BASIN & GRAVITY SEWER IMPROVEMENTS

TRAFFIC CONTROL PLAN - PHASE 1 SSEE

DESCRIPTION

APPROVED

		ON: BELLEVUI EMPHIS, TENN	
SURVEY: GEODESY	DATE:	4/5/2021	В
DRAWN: ABES	DATE:	1/28/2025	S
DESIGN: ABES	DATE:	1/28/2025	С

SCALE: AS SHOWN CHECKED: _____ DATE:____ REVIEWED

CITY ENGINEER DATE DATE DEPUTY CITY ENGINEER FILE FOLDER. SHEET NUBMER

<u>BELLEVUE BAPTIST CHURCH</u> PARCEL II OF: GALLERIA OF MEMPHIS EXISTING FRESHWATER WETLAND PLAT BOOK 204 PAGE 40 (CLASSIFIED PFO1A) D BELLEVUE PKWY NEW 42" INTERCEPTOR

BELLEVUE PKWY TCP (PHASE 2)

SCALE: 1" = 50'

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TRAFFIC CONTROL LEGEND		
SYMBOL	ITEM	
7777	WORK ZONE	
•	FLEXIBLE DRUMS (CHANNELIZING)	
Þ	SIGN (CONSTRUCTION)	
•=	FLAGGER	

10 MPH


1 MONTH


DESIGN SPEED LIMIT:

DURATION (PHASE 2):_

BASIS OF ELEVATIONS NAVD 88 CITY BM#235 - LOCATED ON THE SOUTHEAST CORNER OF GERMANTOWN PKWY AND CHIMNEYROCK BLVD, AT BACK OF SIDEWALK, ER ON CHIMNEYROCK BLVD. SIDE. ELEV. 296.21

THESE PREMISES ARE NOT LOCATED WITHIN A "SPECIAL FLOOD HAZARD AREA" AS DEFINED BY NATIONAL FLOOD PROTECTION ACT AS SHOWN ON FIRM MAP 47157C0316G AND 47157C0310G, DATED FEBRUARY 05, 2013.

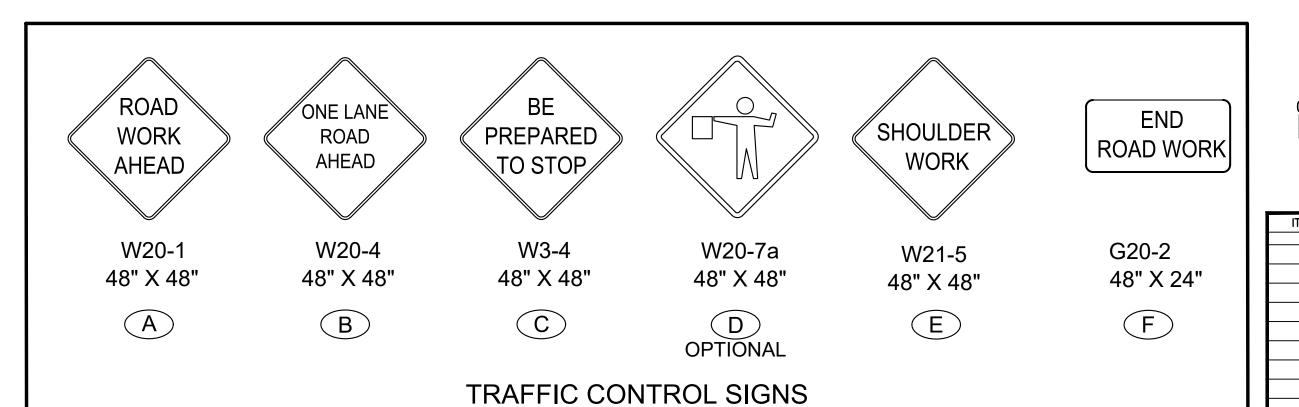

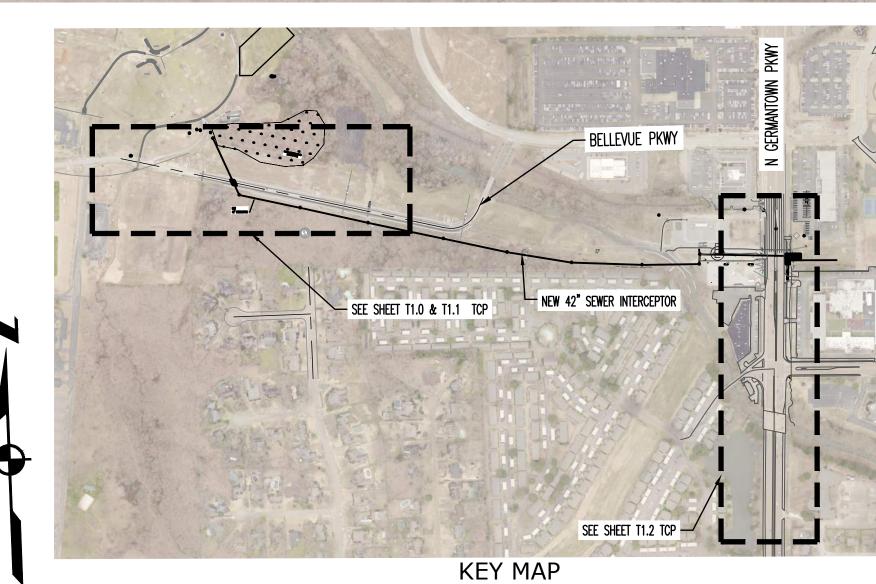

SCALE: 1'' = 500'

DESCRIPTION

APPROVED

SEWER BASIN WN-10 SHEET 2 OF 3

DIVISION OF ENGINEERING **SARP10** BELLEVUE EQ. BASIN & GRAVITY SEWER IMPROVEMENTS TRAFFIC CONTROL PLAN - PHASE 2

LOCATION: BELLEVUE PARKWAY MEMPHIS, TENNESSEE


SURVEY: <u>GEODESY</u> DATE: <u>4/5/2021</u> BOOK: __ DATE: 1/28/2025 SCALE: AS SHOWN DRAWN: ABES DESIGN: ABES DATE: 1/28/2025 CHECKED: _____ DATE:____


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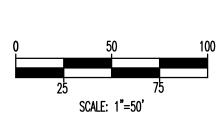


TRAFFIC CONTROL LEGEND		
SYMBOL	ITEM	
	WORK ZONE	
•	FLEXIBLE DRUMS (CHANNELIZING)	
Þ	SIGN (CONSTRUCTION)	
•=	FLAGGER	

DESIGN SPEED LIMIT: 10 MPH DURATION (PHASE 3): 3 MONTHS



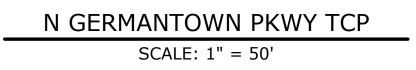


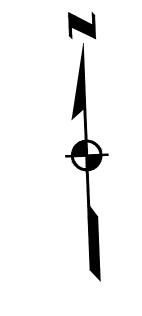

TRAFFIC CONTROL PLAN NOTES


- 1. SEE SECTION 6F.02, SIGN PLACEMENT, OF THE MANUAL ON UNIFORM TRAFFIC CONTROL DEVICES (MUTCD) FOR INFORMATION ON PLACEMENT AND MOUNTING OF SIGNS.
- SIGNS SHOWN ON THIS PLAN ARE TO WARN TRAFFIC ABOUT THE CONSTRUCTION. OTHER TRAFFIC CONTROL DEVICES MAY BE REQUIRED DURING VARIOUS PHASES OF CONSTRUCTION. NOTHING IN THIS PLAN IS INTENDED TO SUPERSEDE OR RELIEVE THE CONTRACTOR OF THE RESPONSIBILITY OF INSTALLING THE APPROPRIATE TRAFFIC CONTROL DEVICES IN ACCORDANCE WITH THE CURRENT
- PRIOR TO COMMENCING CONSTRUCTION OR IMPLEMENTING A TRAFFIC CONTROL PLAN. ALL TRAFFIC CONTROL DEVICES MUST BE IN PLACE BEFORE CONSTRUCTION ACTIVITY BEGINS. 5. SIZES OF ALL SIGNS SHALL COMPLY WITH THE MANUAL ON UNIFORM TRAFFIC CONTROL DEVICES (MUTCD).
- 6. ALL TRAFFIC CONTROL DEVICES AND THEIR INSTALLATION SHALL MEET THE STANDARD PRESCRIBED IN THE MANUAL ON UNIFORM TRAFFIC CONTROL DEVICES AND SHALL COMPLY WITH THE STATE OF
- TENNESSEE STANDARD SPECIFICATIONS FOR ROAD AND BRIDGE CONSTRUCTION SECTION 712 TEMPORARY TRAFFIC CONTROL.
- ACCESS TO ADJACENT PROPERTIES SHALL BE MAINTAINED AT ALL TIMES.
- 8. SIDE STREET, DRIVEWAY ACCESS, AND SAFE PEDESTRIAN WAYS SHALL BE MAINTAINED AT ALL TIMES. THE CONTRACTOR SHALL NOT BE PERMITTED TO PARK ANY VEHICLES OR CONSTRUCTION EQUIPMENT DURING PERIODS OF INACTIVITY, WITHIN THE RIGHT-OF-WAY OR WITHIN THIRTY (30) FEET OF THE EDGE OF PAVEMENT WHICHEVER IS LESS, WHEN THE LANE IS OPEN TO TRAFFIC, UNLESS PROTECTED BY GUARDRAIL, BRIDGE RAIL, AND/OR BARRIERS INSTALLED FOR OTHER PURPOSES. PRIVATELY OWNED VEHICLES
- SHALL NOT BE ALLOWED TO BE PARKED WITHIN THE RIGHT-OF-WAY OR WITHIN THIRTY (30) FEET OF AN OPEN TRAFFIC LANE WHICHEVER IS LESS, AT ANY TIME UNLESS PROTECTED AS DESCRIBED ABOVE. 10. CONTRACTOR SHALL USE PLASTIC DRUMS WITH TYPE "A" WARNING LIGHTS TO SEPARATE TRAFFIC FROM THE CONSTRUCTION AREA. 11. DRUMS WITH TYPE "A" WARNING LIGHTS SHALL DELINEATE THE EDGE OF PAVEMENT THROUGH THE ENTIRE CONSTRUCTION AREA.
- 12. CONTRACTOR SHALL COVER ALL EXISTING SIGNS THAT CONFLICT WITH THE TRAFFIC CONTROL PLAN SIGNS OR DEVICES DURING CONSTRUCTION AND THEY SHALL REMAIN COVERED DURING CONSTRUCTION AND UNTIL SUCH TIME THAT NO CONFLICT EXISTS.
- 13. CONTRACTOR SHALL INSTALL TEMPORARY NO PARKING SIGNS AS REQUIRED WITHIN THE TRAFFIC CONTROL AREA.
- 14. WORK WITHIN THE ROADWAY DURING DIFFERENT PHASES OF CONSTRUCTION SHALL NOT BE ACTIVE AT THE SAME TIME.
- 15. ONLY ONE PHASE OF THE TRAFFIC CONTROL PLAN SHALL BE ACTIVE AT ANY ONE TIME.
- 16. ALL TEMPORARY OR PERMANENT TRAVELED SURFACE SHALL BE INSPECTED DAILY BY THE CONTRACTOR (INCLUDING WEEKENDS) AND NECESSARY PATCHING OR RE-FINISHING PERFORMED.
- 17. THE CONTRACTOR SHALL CONTACT THE CITY OF MEMPHIS TRAFFIC ENGINEERING DEPARTMENT AT 901-636-6710 AT LEAST ONE WEEK PRIOR TO IMPLEMENTING THE TRAFFIC CONTROL PLAN TO DETERMINE FEES ASSOCIATED WITH ANY ENGINEERING PERMITS REQUIRED (I.E. DUMPSTER PERMITS, PARKING METER PERMITS, ETC.).
- 18. CHANNELIZING DEVICES SHALL BE REMOVED TO THE EDGE OF PAVEMENT AT THE END OF EACH WORK DAY. NO CLOSURE SHALL BE IN EFFECT FROM 4:00 P.M. UNTIL 9:00 A.M. TWO 12 FOOT LANES SHALL BE OPEN DURING THIS PERIOD WITH AT LEAST A 4 INCH THICK COMPACTED GRAVEL SURFACE. 19. WORK WITHIN THE ROADWAY SHALL BE CONDUCTED BETWEEN 9:00 A.M. AND 4:00 P.M. AND THE ROADWAY SHALL BE COMPLETELY OPEN TO TRAFFIC AT ALL OTHER TIMES AND ALL INAPPROPRIATE SIGNS SHALL
- 20. AT NO TIME SHALL ONE LANE SECTION BE LEFT OPEN UNATTENDED. WHERE TWO FLAGGERS ARE REQUIRED AND IN CIRCUMSTANCES WHERE ONLY ONE LANE OF TRAFFIC IS OPEN AND THERE IS NO CLEAR LINE
- OF SIGHT FROM ONE END OF THE CONSTRUCTION AREA TO THE OTHER, THE CONTRACTOR SHALL PROVIDE RADIO COMMUNICATION OR OTHER APPROPRIATE MEANS OF ESTABLISHING CONTROL OF TRAFFIC. CONTRACTOR SHALL CONTACT THE CITY OF MEMPHIS SIGNAL SHOP AT 528-2844 FOR LOCATION OF SIGNAL CONDUIT AND WIRES. 22. THE APPROPRIATE TRAFFIC CONTROL SHALL BE INSTALLED AT THE INCEPTION OF EACH STAGE OF CONSTRUCTION AND SHALL BE PROPERLY MAINTAINED AND/OR OPERATED DURING THE TIME SUCH SPECIAL
- CONDITIONS EXIST. THEY SHALL REMAIN IN PLACE ONLY AS LONG AS THEY ARE NEEDED AND SHALL BE IMMEDIATELY REMOVED THEREAFTER. 23. OBLITERATED MARKINGS SHALL BE UNIDENTIFIABLE AS PAVEMENT MARKINGS UNDER DAY OR NIGHT, WET OR DRY CONDITIONS. OVERLAYING EXISTING STRIPES WITH BLACK PAINT OR ASPHALT DOES NOT MEET THE REQUIREMENTS OF COVERING, REMOVAL, OR OBLITERATION; HOWEVER, THE USE OF REMOVABLE, NON-REFLECTIVE, PREFORMED TAPE IS PERMITTED WHERE MARKINGS NEED TO BE COVERED
- 24. EXISTING STRIPING THAT CONFLICTS WITH THE TEMPORARY TRAFFIC CONTROL DEVICES SHALL BE COVERED OR REMOVED DURING CONSTRUCTION. WHEN CONSTRUCTION IS COMPLETE THE EXISTING
- STRIPING SHALL BE RETURNED TO ITS ORIGINAL STATE. 25. ALL TRAFFIC CONTROL SIGNS SHALL MEET THE MINIMUM RETRO REFLECTIVITY LEVELS SPECIFIED IN THE CURRENT EDITION OF THE MANUAL ON UNIFORM TRAFFIC CONTROL DEVICES (MUTCD).
- 26. THE DEVELOPER SHALL PROVIDE A TRAFFIC CONTROL PLAN TO THE CITY ENGINEER THAT SHOWS THE PHASING FOR EACH STREET FRONTAGE DURING DEMOLITION OR CONSTRUCTION OF CURB, GUTTER AND SIDEWALK. IF A TEMPORARY SIDEWALK IS PROVIDED, IT SHALL BE ADA ACCESSIBLE AND A MINIMUM 5 FEET WIDE PEDESTRIAN PATHWAY.
- 27. ANY CLOSURE OF THE RIGHT OF WAY SHALL BE TIME LIMITED TO THE ACTIVE DEMOLITION OR CONSTRUCTION. CONTINUOUS UNWARRANTED CLOSURE OF THE RIGHT OF WAY SHALL NOT BE ALLOWED FOR THE DURATION OF THE PROJECT. TIME LIMITS WILL BEGIN ON THE DAY OF CLOSURE AND WILL BE MONITORED BY THE ENGINEERING CONSTRUCTION INSPECTORS (901) 636-2462 ON THE JOB.
- 28. ANYTIME FLAGGER IS NOT PRESENT TO CONTROL TRAFFIC, TWO TRAFFIC LANES MUST BE OPEN TO MAINTAIN TWO-WAY TRAFFIC AND ALL INAPPROPRIATE SIGNS SHALL BE COVERED OR REMOVED.
- 29. ALL FLAGGERS SHALL BE EQUIPPED WITH A **STOP/SLOW** PADDLE.



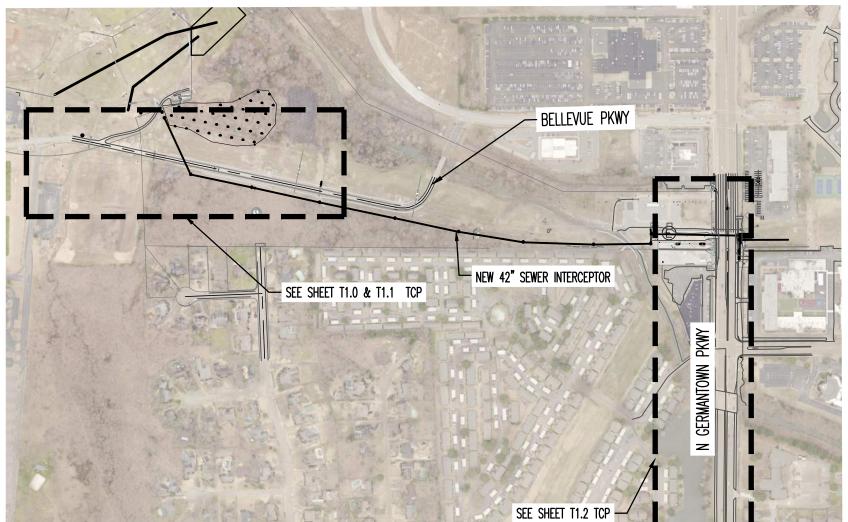

KEY MAP

SCALE: 1'' = 500'

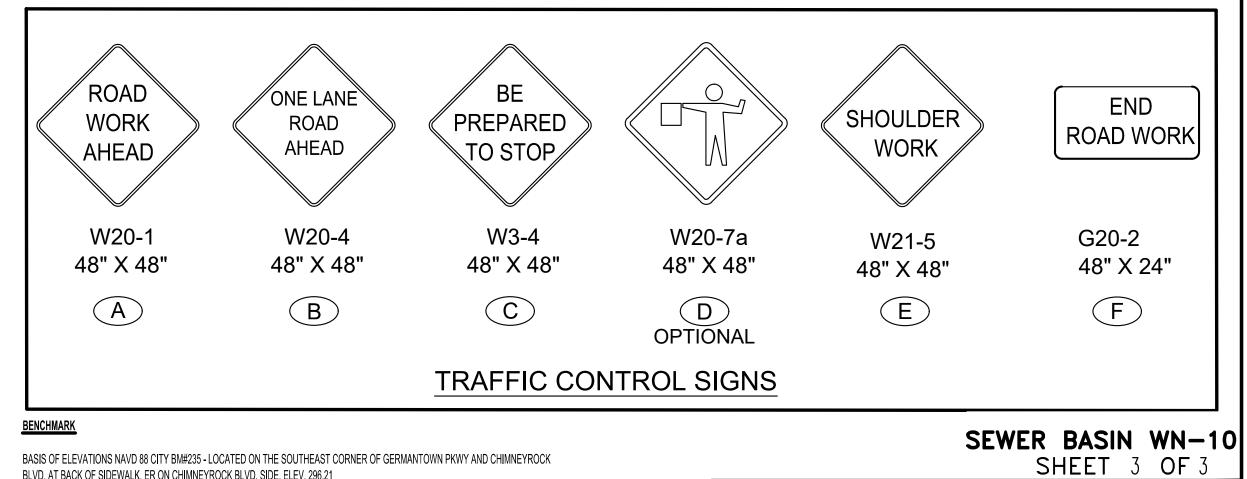

BASIS OF ELEVATIONS NAVD 88 CITY BM#235 - LOCATED ON THE SOUTHEAST CORNER OF GERMANTOWN PKWY AND CHIMNEYROCK BLVD, AT BACK OF SIDEWALK, ER ON CHIMNEYROCK BLVD. SIDE. ELEV. 296.21

THESE PREMISES ARE NOT LOCATED WITHIN A "SPECIAL FLOOD HAZARD AREA" AS DEFINED BY NATIONAL FLOOD PROTECTION ACT AS SHOWN ON FIRM MAP 47157C0316G AND 47157C0310G, DATED FEBRUARY 05, 2013.

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DIVISION OF ENGINEERING **SARP10** BELLEVUE EQ. BASIN & GRAVITY SEWER IMPROVEMENTS

TRAFFIC CONTROL PLAN - N GERMANTOWN PWKY

LOCATION: BELLEVUE PARKWAY MEMPHIS, TENNESSEE

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